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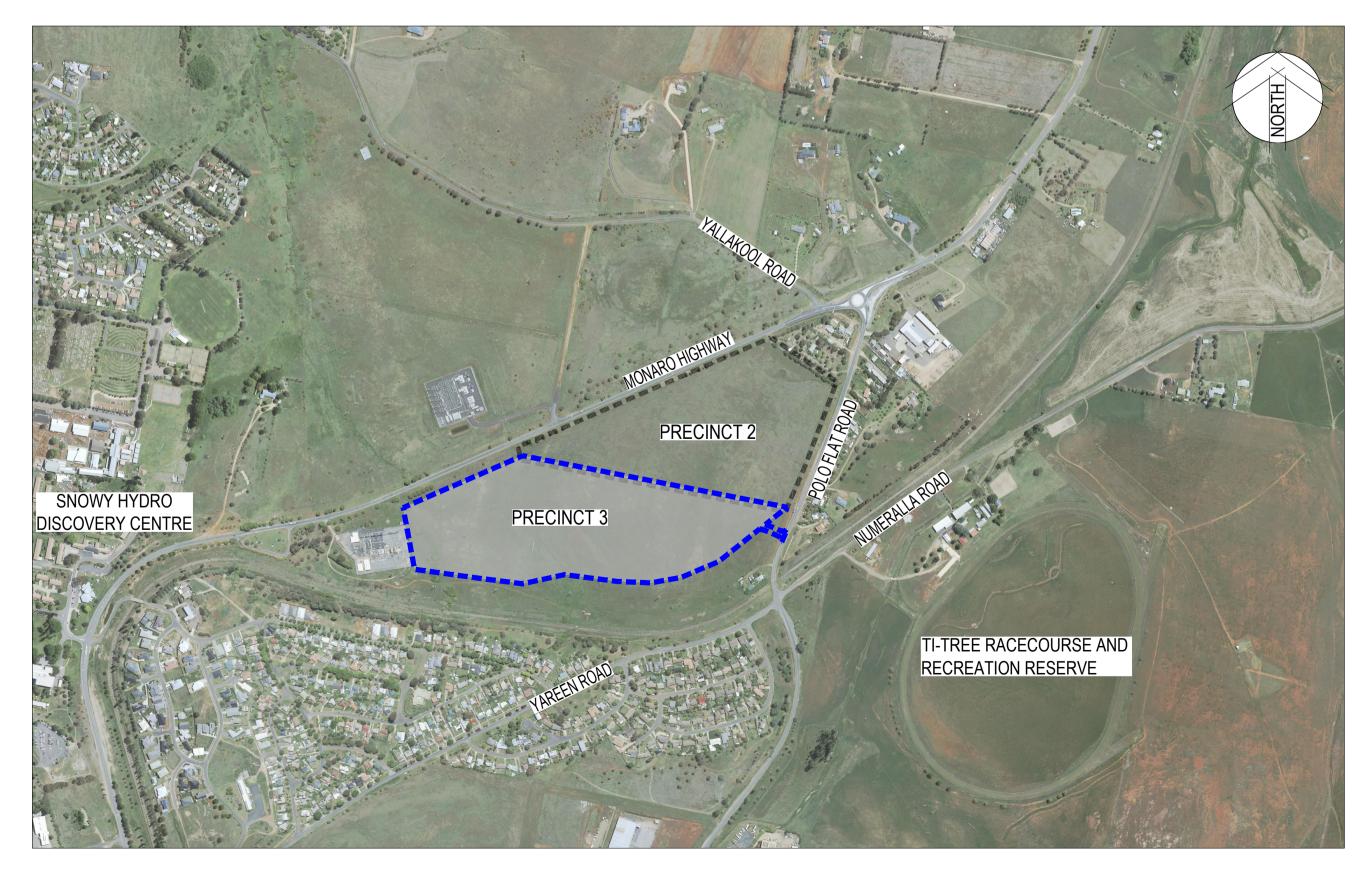


NSW Department of Planning and Environment

# POLO FLAT ROAD RESIDENTIAL DEVELOPMENT (PRECINCT 3, LOT 3 DP 1285072)

COVER SHEET AND LOCALITY PLAN November 2022

## FOR DEVELOPMENT APPLICATION - BGYV7





	SCHEDULE OF DRAWINGS
DRAWING No.	DESCRIPTION
50522046-C-3000	COVER SHEET AND LOCALITY PLAN FOR DEVELOPMENT APPLICATION
50522046-C-3001	LOCALITY PLAN AND DRAWING SCHEDULE
50522046-C-3002	EXISTING SITE PLAN
50522046-C-3003	NOTES AND LEGEND
50522046-C-3005	GENERAL ARRANGEMENT PLAN
50522046-C-3010	EXISTING ZONING PLAN
50522046-C-3011	BUSHFIRE ASSET PROTECTION PLAN
50522046-C-3012	ROAD HIERARCHY PLAN
50522046-C-3015	TYPICAL ROAD CROSS SECTIONS
50522046-C-3020	ROAD LONG SECTIONS ROAD 02 SHEET 1 OF 2
50522046-C-3021	ROAD LONG SECTIONS ROAD 02 SHEET 2 OF 2
50522046-C-3022	ROAD LONG SECTIONS ROAD 03, ROAD 04 AND ROAD 05
50522046-C-3023	ROAD LONG SECTIONS ROAD 06
50522046-C-3024	ROAD LONG SECTIONS ROAD 7A
50522046-C-3030	ACTIVE TRAVEL PLAN
50522046-C-3032	ISOPACH
50522046-C-3034	RETAINING WALL PLAN
50522046-C-3035	TYPICAL CUT/FILL SECTIONS SHEET 1 OF 2
50522046-C-3036	TYPICAL CUT/FILL SECTIONS SHEET 2 OF 2
50522046-C-3040	CONCEPT STORMWATER PLAN
50522046-C-3041	WATER SENSITIVE URBAN DESIGN OUTCOME PLAN AND QUALITY TABLE
50522046-C-3042	WATER SENSITIVE URBAN DESIGN SPEL ECOCEPTOR - SERIES 10000
50522046-C-3045	CONCEPT SEWER PLAN
50522046-C-3050	CONCEPT WATER PLAN
50522046-C-3055	CONCEPT SERVICES PLAN
50522046-C-3060	SOIL AND WATER MANAGEMENT PLAN
50522046-C-3065	VEHICLE TURNING PATH ANALYSIS SHEET 1 OF 2
50522046-C-3066	VEHICLE TURNING PATH ANALYSIS SHEET 1 OF 2

SITE PLAN
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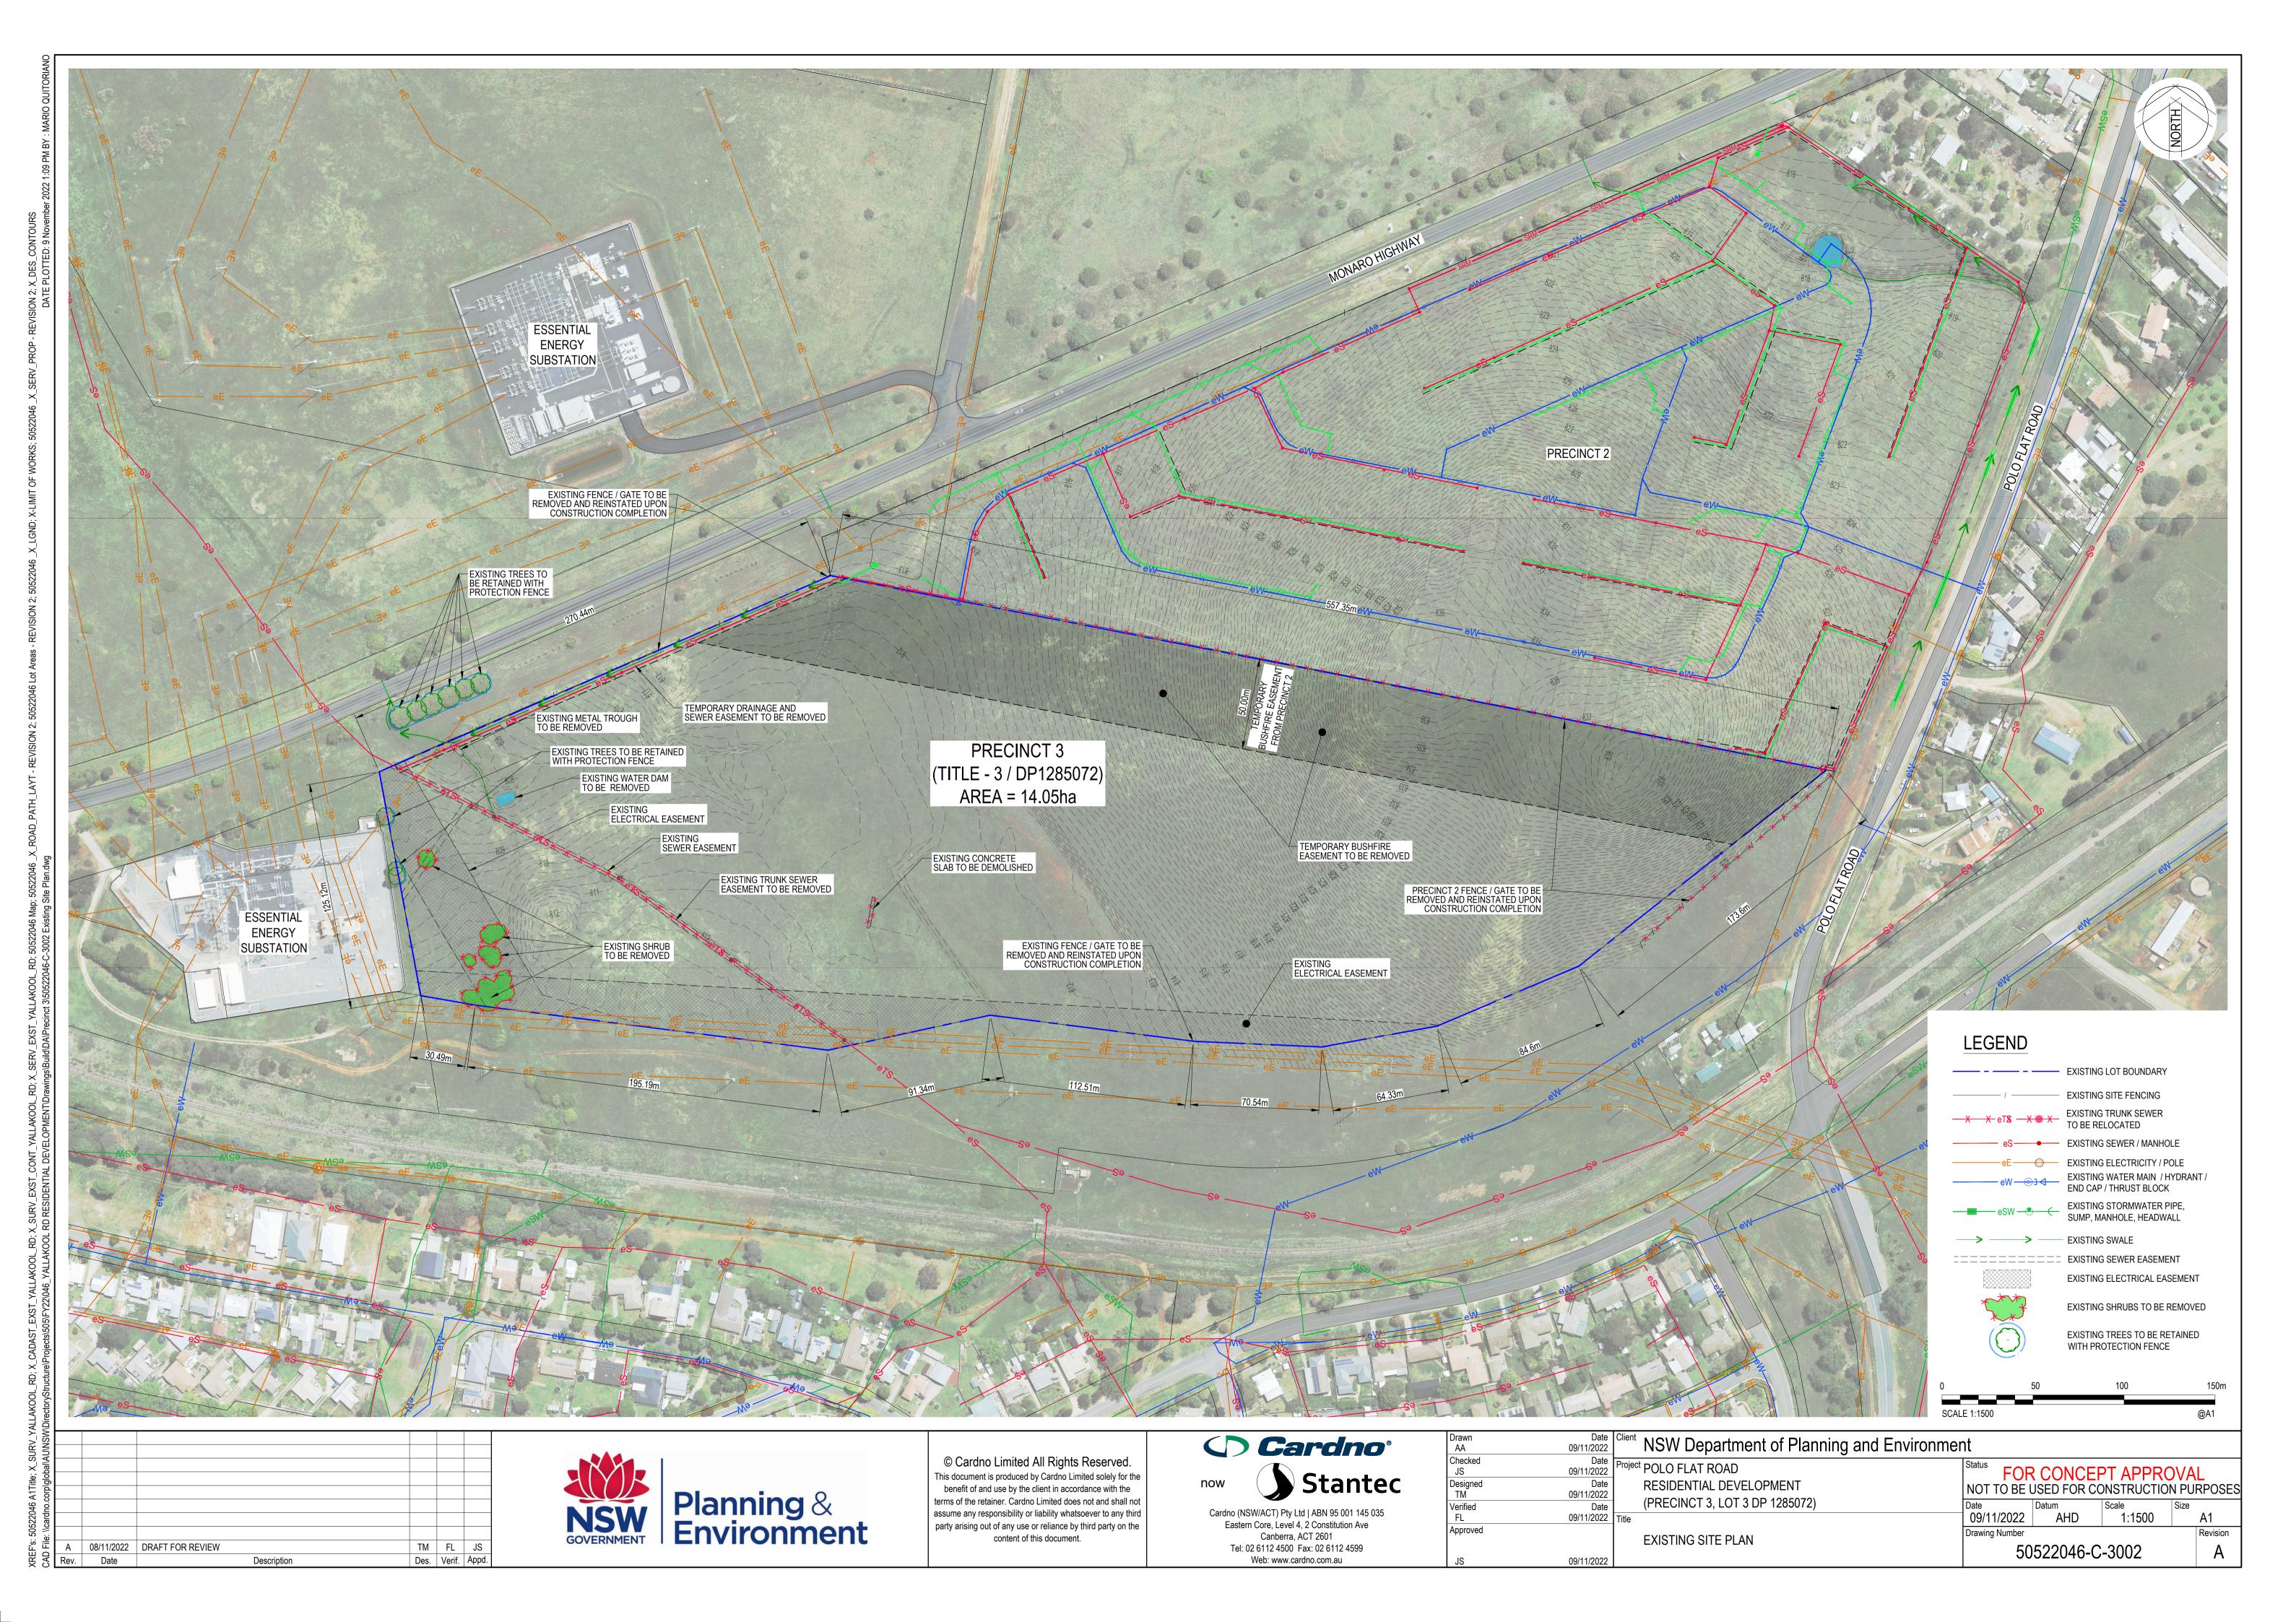
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Date 09/11/2022	Client NSW Department of Planning and Environmen	nt		
Date 09/11/2022 Date 09/11/2022	Project POLO FLAT ROAD RESIDENTIAL DEVELOPMENT	FOR CONCEP NOT TO BE USED FOR CO		
Date 09/11/2022	(PRECINCT 3, LOT 3 DP 1285072)	I	Scale Si. AS SHOWN	ze A1
	LOCALITY PLAN AND DRAWING SCHEDULE	Drawing Number	,	Revision
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#### **GENERAL NOTES**

- 1. THE CONTRACTOR SHALL COMPLY WITH THE REQUIREMENTS OF THE OCCUPATIONAL HEALTH AND SAFETY ACT 2000, WHICH REQUIRES EMPLOYERS TO ENSURE THE HEALTH, SAFETY AND WELFARE OF EMPLOYEES.
- 2. THE CONTRACTOR SHALL AT ALL TIMES EXERCISE ALL NECESSARY PRECAUTIONS APPROPRIATE TO ENSURE THE SAFETY OF ALL PERSONS ON THE WORK SITE OR IN THE VICINITY OF THE WORK SITE.
- 3. SEDIMENT AND EROSION CONTROL MEASURES AS DETAILED ON THE EROSION AND SEDIMENT CONTROL PLAN AND IN ACCORDANCE WITH LANDCOM'S SOILS AND CONSTRUCTION VOLUME 1, 4TH EDITION MARCH 2004 AND SNOWY MONARO REGIONAL COUNCIL'S DEVELOPMENT DESIGN SPECIFICATION D7.
- 4. ALL CONSTRUCTION WORK IS TO BE CARRIED OUT SO THAT AT ANY TIME ADJOINING PROPERTY OWNERS ARE NOT DEPRIVED OF AN ALL-WEATHER ACCESS OR SUBJECTED TO ADDITIONAL STORM WATER RUN-OFF DURING THE PERIOD OF CONSTRUCTION.
- 5. TO LIMIT THE IMPACT OF THE CONSTRUCTION ON ADJOINING OWNERS, ALL WORKS SHALL BE RESTRICTED TO THE HOURS OF 7am-6pm MONDAY TO FRIDAY AND 8am-3pm SATURDAY. NO WORK SHALL TAKE PLACE ON SUNDAYS OR PUBLIC HOLIDAYS.
- 6. ALL WORK IS TO BE SET OUT BY A COMPETENT SURVEYOR APPROVED BY COUNCIL
- 7. THE CONTRACTOR SHALL NOT DISTURB ANY SURVEY CONTROL MARKS. SHOULD ANY SURVEY CONTROL MARK BE DISTURBED OR OBLITERATED, THE CONTRACTOR SHALL NOTIFY THE SUPERINTENDENT IMMEDIATELY. THE CONTRACTOR SHALL HAVE THE MARKS REPLACED AT HIS EXPENSE.
- 8. ALL WORKS ARE TO BE CONDUCTED TO THE REQUIREMENTS OF THE SUBDIVISION MANAGER OR DELEGATE.
- 9. ALL GREEN WASTE IS TO BE MULCHED. STOCKPILED AND USED (WHERE POSSIBLE) ON SITE, ALL EXCESS MULCH IS TO BE REMOVED OFF SITE.
- 10. THE DEPTH OF PAVEMENT MATERIAL SHALL BE APPROVED BY SNOWY MONARO REGIONAL COUNCIL WITH REFERENCE TO THE ACT GEOTECHNICAL ENGINEER'S PTY LTD PAVEMENT DESIGN REPORT. THE TYPE OF PAVEMENT MATERIAL IS TO BE APPROVED BY SNOWY MONARO REGIONALCOUNCIL.
- 11. THE SURVEYOR IS TO BE NOTIFIED 1 WEEK PRIOR TO THE POURING OF KERB SO SSMs AND THEIR LOCATIONS CAN BE PROVIDED.
- 12. ALL DISTURBED AREAS INCLUDING BATTERS, TABLE DRAINS AND FOOTPATH AREAS ARE TO BE TOP SOILED, FERTILIZED AND SEEDED TO THE SATISFACTION OF COUNCIL'S SUBDIVISION MANAGER OR DELEGATE. THE TYPE OF SEED (NATIVE MIX) IS TO BE APPROVED BY THE SUPERINTENDENT.
- 13. IF ROCK IS ENCOUNTERED THE SUPERINTENDENT SHALL BE NOTIFIED IMMEDIATELY SO MEASUREMENTS OF VOLUMES CAN BE MADE. NO VARIATIONS FOR ROCK WILL BE CONSIDERED UNLESS THE SUPERINTENDENT HAS VERIFIED THE AMOUNTS PRIOR TO BACKFILLING.
- 14. ALL WORKS TO BE CARRIED OUT IN ACCORDANCE WITH THE COOMA-MONARO SPECIFICATION FOR ENGINEERING WORKS CONSTRUCTION COUNCIL. AND TO THE REQUIREMENTS OF THE PRINCIPAL CERTIFYING AUTHORITY.
- 15. SEDIMENT AND EROSION CONTROL MEASURES ARE TO BE IMPLEMENTED PRIOR TO CONSTRUCTION WORK COMMENCING AND MAINTAINED DURING THE CONSTRUCTION PHASE. SEDIMENT AND EROSION CONTROL MEASURES ARE TO INCORPORATE THOSE AS DETAILED ON THE SEDIMENT AND EROSION CONTROL PLAN. MEASURES SHOULD ALSO INCORPORATE THOSE AS SET OUT IN COUNCIL'S STANDARDS DURING THE INSTALLATION OF UTILITY SERVICES.
- 16. THE CONTRACTOR IS TO GAIN APPROVAL UNDER SECTION 138 OF THE ROADS ACT 1993 PRIOR TO COMMENCING CONSTRUCTION WITHIN ALL ROAD RESERVES.
- 17. TRAFFIC CONTROL MEASURES IN ACCORDANCE WITH AS 1742.3 ARE TO BE IN PLACE AND MAINTAINED AT ALL TIMES. TRAFFIC CONTROL PLAN IS TO BE SUBMITTED TO COUNCIL AND APPROVED PRIOR TO CONSTRUCTION WORK COMMENCING.
- 18. PRIOR TO COMMENCEMENT OF EXCAVATION THE CONTRACTOR SHALL DETERMINE THE LOCATION OF ALL SERVICES AND WILL BE RESPONSIBLE FOR ADJUSTMENT OF SERVICES AND REPAIR OF ANY DAMAGE TO COUNCIL'S INFRASTRUCTURE. SUCH REINSTATEMENT TO BE CARRIED OUT IMMEDIATELY TO THE SATISFACTION OF THE SUBDIVISION AND DEVELOPMENT MANAGER.

### DRAINAGE NOTES

- 1. ALL STORMWATER WORKS TO BE CARRIED OUT IN ACCORDANCE WITH COOMA MONARO SPECIFICATION FOR ENGINEERING WORKS - CONSTRUCTION, C220 - STORMWATER.
- 2. PIPES ARE TO BE LAID TO DESIGN LEVELS AND GRADES IN 10mm AGGREGATE BED (MIN 75mm DEEP). BACKFILL PIPES 100mm OVER TOP OF BARREL WITH 10mm AGGREGATE AND TO FINISHED SURFACE LEVEL WITH SELECTED BACKFILL.
- 3. PITS MORE THAN 1.0m DEEP TO HAVE STEP IRONS.
- 4. SUBSOIL DRAINAGE LINES ARE TO BE LAID AT A MINIMUM GRADE OF 1%.
- 5. STORMWATER PIPES TO BE uPVC SN8 MANUFACTURED TO AS1254, INSTALLED IN ACCORDANCE WITH

## WATER RETICULATION MAIN NOTES:

- 1. ALL WATER MAIN WORKS TO BE CARRIED OUT IN ACCORDANCE WITH COOMA MONARO SPECIFICATION FOR ENGINEERING WORKS CONSTRUCTION, C401 - WATER RETICULATION.
- 2. PE PIPE SHALL COMPLY WITH AS/NZ 4130.
- 3. FITTINGS USED ON PE PIPE SHALL COMPLY WITH AS/NZ 4129.
- THE PE COMPOUND SHALL BE PE80B OR PE100 AND SHALL COMPLY WITH AS/NZ 4131.
- 5. PE MAY BE COLD BENT TO A MINIMUM RADIUS OF 33xOD. STAKES OR OTHER SOURCES OF POINT LOADS SHALL NOT BE USED TO ASSIST IN BENDING THE PIPE.
- 6. ALLOWANCE SHALL BE MADE DURING CONSTRUCTION FOR EXPANSION AND CONTRACTION OF PE PIPE DUE TO TEMPERATURE CHANGES.
- 7. PE PIPE SHALL BE BLACK PIPE WITH BLUE STRIPES.
- 8. NOMINATED DIAMETER IS O.D. U.N.O.

#### SEWER NOTES

- ALL SEWER WORKS TO BE CARRIED OUT IN ACCORDANCE WITH COOMA MONARO SPECIFICATION FOR ENGINEERING WORKS CONSTRUCTION, C402 - SEWERAGE SYSTEM.
- SEWER PIPE CLASS SN8, FLEXIBLE RUBBER RING (ELASTOMERIC) JOINTS, MANUFACTURED TO

#### PAVEMENT NOTES

- 1. ALL SUBGRADE AND SUBBASE ARE TO BE COMPACTED TO A MINIMUM DENSITY OF 100% OF THE STANDARD MAXIMUM DRY DENSITY.
- 2. BASE COURSE MATERIALS ARE TO BE COMPACTED TO A MINIMUM DENSITY RATIO OF 98% OF THE MODIFIED MAXIMUM DRY DENSITY WITHIN -1.0% TO 3.0% OF STANDARD OPTIMAL MOISTURE
- DESIGN SUBGRADE CBR VALUES AND ADOPTED TRAFFIC LOADING ARE NOTED WITH EACH INDIVIDUAL PAVEMENT TYPE. APPROPRIATE SUBGRADE TREATMENT SHOULD BE ASSESSED AFTER PRELIMINARY BOXING. A NON WOVEN GEOFABRIC LAYER SUCH AS BIDUM A34 SHOULD BE PLACED ON SUBGRADE TO ACT AS A SEPARATION LAYER WHERE WET AND DEFLECTING SUBGRADE CONDITIONS ARE ENCOUNTERED.
- 4. PAVEMENT SUBGRADE COMPACTION SHOULD MEET THE FOLLOWING MINIMUM SPECIFICATION WHICH IS AS FOLLOWS:

**BASECOURSE** 98% MDD SUB-BASE 98% MOD SUBGRADE 98% MDD.

WHERE EXISTING CBR VALUES OF LESS THAN 3% ARE ENCOUNTERED. SUBGRADES COULD BE CEMENTED OF LIME STABILISED TO A DEPTH OF 150mm, WITH DESIGN THEN BASED ON A VALUE OF 3%. ALTERNATIVELY, THE LOW STRENGTH SUBGRADES COULD BE TREATED BY EXCAVATION OF AT LEAST AN ADDITIONAL 300mm FOLLOWED BY REPLACEMENT WITH SUITABLE GRANULAR MATERIAL, THUS SATISFYING THE REQUIREMENTS OF A CBR 3% SUBGRADE.

## EARTHWORKS NOTES

- SET OUT OF WORKS ON SITE ARE TO APPROVED BY THE PRINCIPAL'S REPRESENTATIVE PRIOR TO CONSTRUCTION WORKS.
- ALL TOPSOIL UNDER THE DESIGN FOOTPRINT IS TO BE STRIPPED TO A MAXIMUM DEPTH OF 300MM AND IS TO BE STOCKPILED FOR FUTURE USE.
- ALL UNSUITABLE IN-SITU FOUNDATION MATERIAL IS TO BE STRIPPED AND STOCKPILED SEPARATELY PRIOR TO CONSTRUCTION.
- ALL IMPORT FILL TO BE PLACED AND SPREAD IN 300MM LOOSE LAYERS, MOISTURE CONDITIONED TO OMC ± 2% AND COMPACTED TO 95% MMDD BEFORE THE END OF EACH **WORKING DAY**
- ALL EARTHWORKS OPERATIONS ARE TO BE SUPERVISED AND CERTIFIED BY A QUALIFIED GEOTECHNICAL ENGINEER AND UNDERTAKEN UNDER LEVEL 1 SUPERVISION.
- FREQUENCY OF COMPACTION TESTING SHALL BE IN ACCORDANCE WITH AS 3798 AND COOMA MONARO SPECIFICATION FOR ENGINEERING WORKS - CONSTRUCTION, C213 - EARTHWORKS.
- COMPACTED AREAS ARE TO BE EITHER COVERED OR TREATED WITH A SUITABLE POLYMER OR ALTERNATIVE METHOD TO PREVENT WATER EROSION OR DUST BLOW BEFORE THE END OF EACH WORKING DAY. THE PREFERRED OPTION IS TO BE APPROVED BY THE PRINCIPAL'S REPRESENTATIVE.
- LANDSCAPED AREAS ARE TO BE COMPACTED TO 90% MMDD.

#### RETAINING WALL NOTES

ALL RETAINING WALL WORKS TO BE CARRIED OUT IN ACCORDANCE WITH COOMA-MONARO SPECIFICATION FOR ENGINEERING WORKS - CONSTRUCTION, C271-MINOR CONCRETE WORKS.

#### TRAFFIC AND PEDESTRIAN MANAGEMENT

- THE CONTRACTOR SHALL PROVIDE SAFE AND UNRESTRICTED ACCESS THROUGHOUT THE CONSTRUCTION PERIOD FOR PEDESTRIANS, CYCLISTS AND VEHICLES.
- 2. THE CONTRACTOR SHALL ENSURE TRAFFIC AND PEDESTRIANS ARE PROTECTED FROM CONSTRUCTION VEHICLES, DUST, WATER AND OTHER NUISANCE BY MEANS OF TEMPORARY SCREENS, BARRIERS, SIGNAGE AND FENCING.
- THE CONTRACTOR SHALL PREPARE AND GAIN APPROVAL FOR A TEMPORARY TRAFFIC MANAGEMENT PLAN, FOLLOWING ENDORSEMENT FROM COOMA - MONARO SPECIFICATION FOR ENGINEERING WORKS CONSTRUCTION C201 - CONTROL OF TRAFFIC.

#### VERGE MANAGEMENT

- THERE SHALL BE NO PARKING, SITE SHEDS, SITE AMENITIES, BILLBOARDS OR STORAGE OF MATERIALS ON THE VERGE, OVERLAND FLOW PATHS OR OPEN SPACE UNDER ANY CIRCUMSTANCES. PROTECT ALL GRASSLAND, TREES AND SHRUBS OUTSIDE THE WORKS AREA FROM DAMAGE.
- ANY WORKS THAT ALTER OR DISTURB GRASSED FLOODWAYS, VERGE AREAS, MEDIANS OR OTHER OPEN AREAS MUST BE REINSTATED TO EXISTING CONDITION BY THE PERSON(S) RESPONSIBLE FOR THE DISTURBANCE IN ACCORDANCE WITH THE CANBERRA LANDSCAPE GUIDELINES.
- 3. FENCING TO PROTECT EXISTING VERGE (REFER LEGEND)
- a. FENCING TO BE ERECTED ON COMMENCEMENT OF SITE WORK AND REMOVED AT COMPLETION OF COMMENCEMENT OF VERGE RESTORATION.
- b. THE FENCE IS TO REMAIN CONTINUOUS THROUGHOUT THE PROJECT, EXCEPT WHERE SERVICE TRENCHING OCCURS.
- c. REALIGN FENCE TO PROVIDE LANE FOR SERVICE TRENCHING BUT RE-ERECT FENCE TO ENCLOSE TREES BEFORE TRENCHING COMMENCES AND ON COMPLETION OF TRENCHING RETURN TO ORIGINAL FENCE ALIGNMENT
- d. NO ACTIVITY SHALL BE CARRIED OUT WITHIN 2m OF A TREE TO BE RETAINED.
- 4. VERGE RESTORATION IS TO BE OVERSEEN BY A LANDSCAPE ARCHITECT.


ANY WORKS THAT ALTER OR DISTURB GRASSED VERGE AREAS, MEDIANS OR OTHER OPEN AREAS MUST BE REINSTATED TO EXISTING CONDITION BY THE PERSON(S) RESPONSIBLE FOR THE DISTURBANCE TO THE SATISFACTION OF THE SUPERINTENDENT.

- 5. EXISTING TREES:
  - a. ALL TREES ARE TO BE RETAINED AND KEPT UNDAMAGED UNLESS SHOWN OTHERWISE.
  - b. EXISTING CROWN CLEARANCE NOT TO BE ALTERED. c. ENSURE CONSTRUCTION EQUIPMENT CAN PASS BENEATH LOWEST LIMB, THROUGH DRIVEWAY ACCESS.
  - d. CROWNS AND APEX OF CANOPY NOT TO BE ALTERED OR REDUCED.
  - e. ENSURE LIFTING EQUIPMENT AND LOAD CAN CLEAR HEIGHT AND WIDTH OF TREE CROWN WITHOUT DAMAGE TO THE CROWN.
  - f. ANY SERVICE CONNECTIONS WITHIN 2m OF AN EXISTING TREE CANOPY TO BE APPROVED BY SUPERINTENDENT.
  - g. EXCAVATION THAT OCCURS WITHIN THE DRIP ZONE OF A TREE MUST BE APPROVED AND IS TO BE RESTRICTED TO ONE SIDE OF THE TREE ONLY.
  - h. WHERE EXCAVATION IS APPROVED THE FOLLOWING MEASURES ARE TO BE ADOPTED FOR TREE
  - DO NOT SEVER LARGE ROOTS (>50mm DIA.) CLOSER THAN HALFWAY FROM THE DRIPLINE TO THE
  - ALL ROOTS MUST BE CUT CLEANLY WITH EQUIPMENT SPECIFICALLY DESIGNED TO CUT ROOTS OR OTHER PRUNING EQUIPMENT.
  - ROOTS EXPOSED DURING EXCAVATION MUST BE PROTECTED FROM DESICCATION. KEEP LIGHTLY
  - WATERED OR COVER WITH HESSIAN WHICH MUST BE KEPT MOIST. WATER TREES WHICH HAVE HAD DISTURBANCE IN THEIR ROOT ZONE. THE AMOUNT AND
  - FREQUENCY OF WATER NEEDS TO BE ADAPTED TO THE TREES' REQUIREMENT, BASED ON SEASONAL CONDITIONS.

## DETAIL OF INVERT LEVELS SUMPS AND SW MANHOLES

#### **EXISTING SERVICES**

- 1. EXISTING SERVICES HAVE BEEN DIGITISED FROM SUPPLIED DATA. NO GUARANTEE IS GIVEN FOR THE ACCURACY OF THE DETAIL. IT IS THE CONTRACTORS RESPONSIBILITY TO ESTABLISH THE EXACT ALIGNMENT OF ALL EXISTING SERVICES WITHIN THE LIMIT OF WORKS PRIOR TO THE COMMENCEMENT OF WORKS.
- 2. THE CONTRACTOR WILL CONTACT, FOR EACH SERVICE AUTHORITY, THE OFFICER-IN-CHARGE OF THE AREA IN WHICH THE SITE IS LOCATED BEFORE COMMENCING WORK ON THE SITE.
- 3. THE CONTRACTOR WILL INSPECT THE LOCATION OF ALL EXISTING SERVICES AND NOTIFY THE SUPERINTENDENT OF ANY OMISSIONS FROM THE
- 4. THE CONTRACTOR WILL IMMEDIATELY NOTIFY THE SUPERINTENDENT AND THE OFFICER-IN-CHARGE OF THE AREA IN THE EVENT OF DAMAGE TO ANY WATER, GAS, STEAM, COMPRESSED AIR, ELECTRIC, DRAINAGE, SEWERAGE, TELECOMMUNICATIONS, FIRE ALARM, CONTROL CABLE OR OTHER SERVICES
- 5. ALL EXISTING SERVICES WHICH NEW SERVICES, PATHS, ROAD OR OTHER PARTS OF THE NEW WORKS ARE TO PASS UNDER, OVER, IN THE VICINITY OF OR CONNECT TO, ARE TO BE POTHOLED BY THE CONTRACTOR AT THE COMMENCEMENT OF WORKS IN ORDER TO DETERMINE IF THE NEW WORKS CAN BE CONSTRUCTED AS DESIGNED. THE COST OF POTHOLING IS TO BE ALLOWED FOR IN THE RATES GENERALLY. (HOLD POINT).
- DAMAGES OR CONSEQUENTIAL DAMAGES AND DELAY DUE TO FAILURE TO ESTABLISH THE ALIGNMENT OF ALL EXISTING SERVICES ARE THE CONTRACTOR'S RESPONSIBILITY, NO PAYMENT WILL BE MADE FOR ADDITIONAL WORKS OR DAMAGES WHERE THE CONTRACTOR HAS NOT COMPLIED WITH THIS REQUIREMENT.

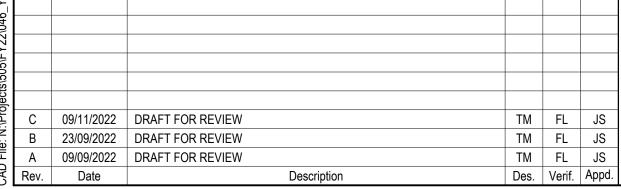



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NSW Department of Planning and Environment oject POLO FLAT ROAD RESIDENTIAL DEVELOPMENT


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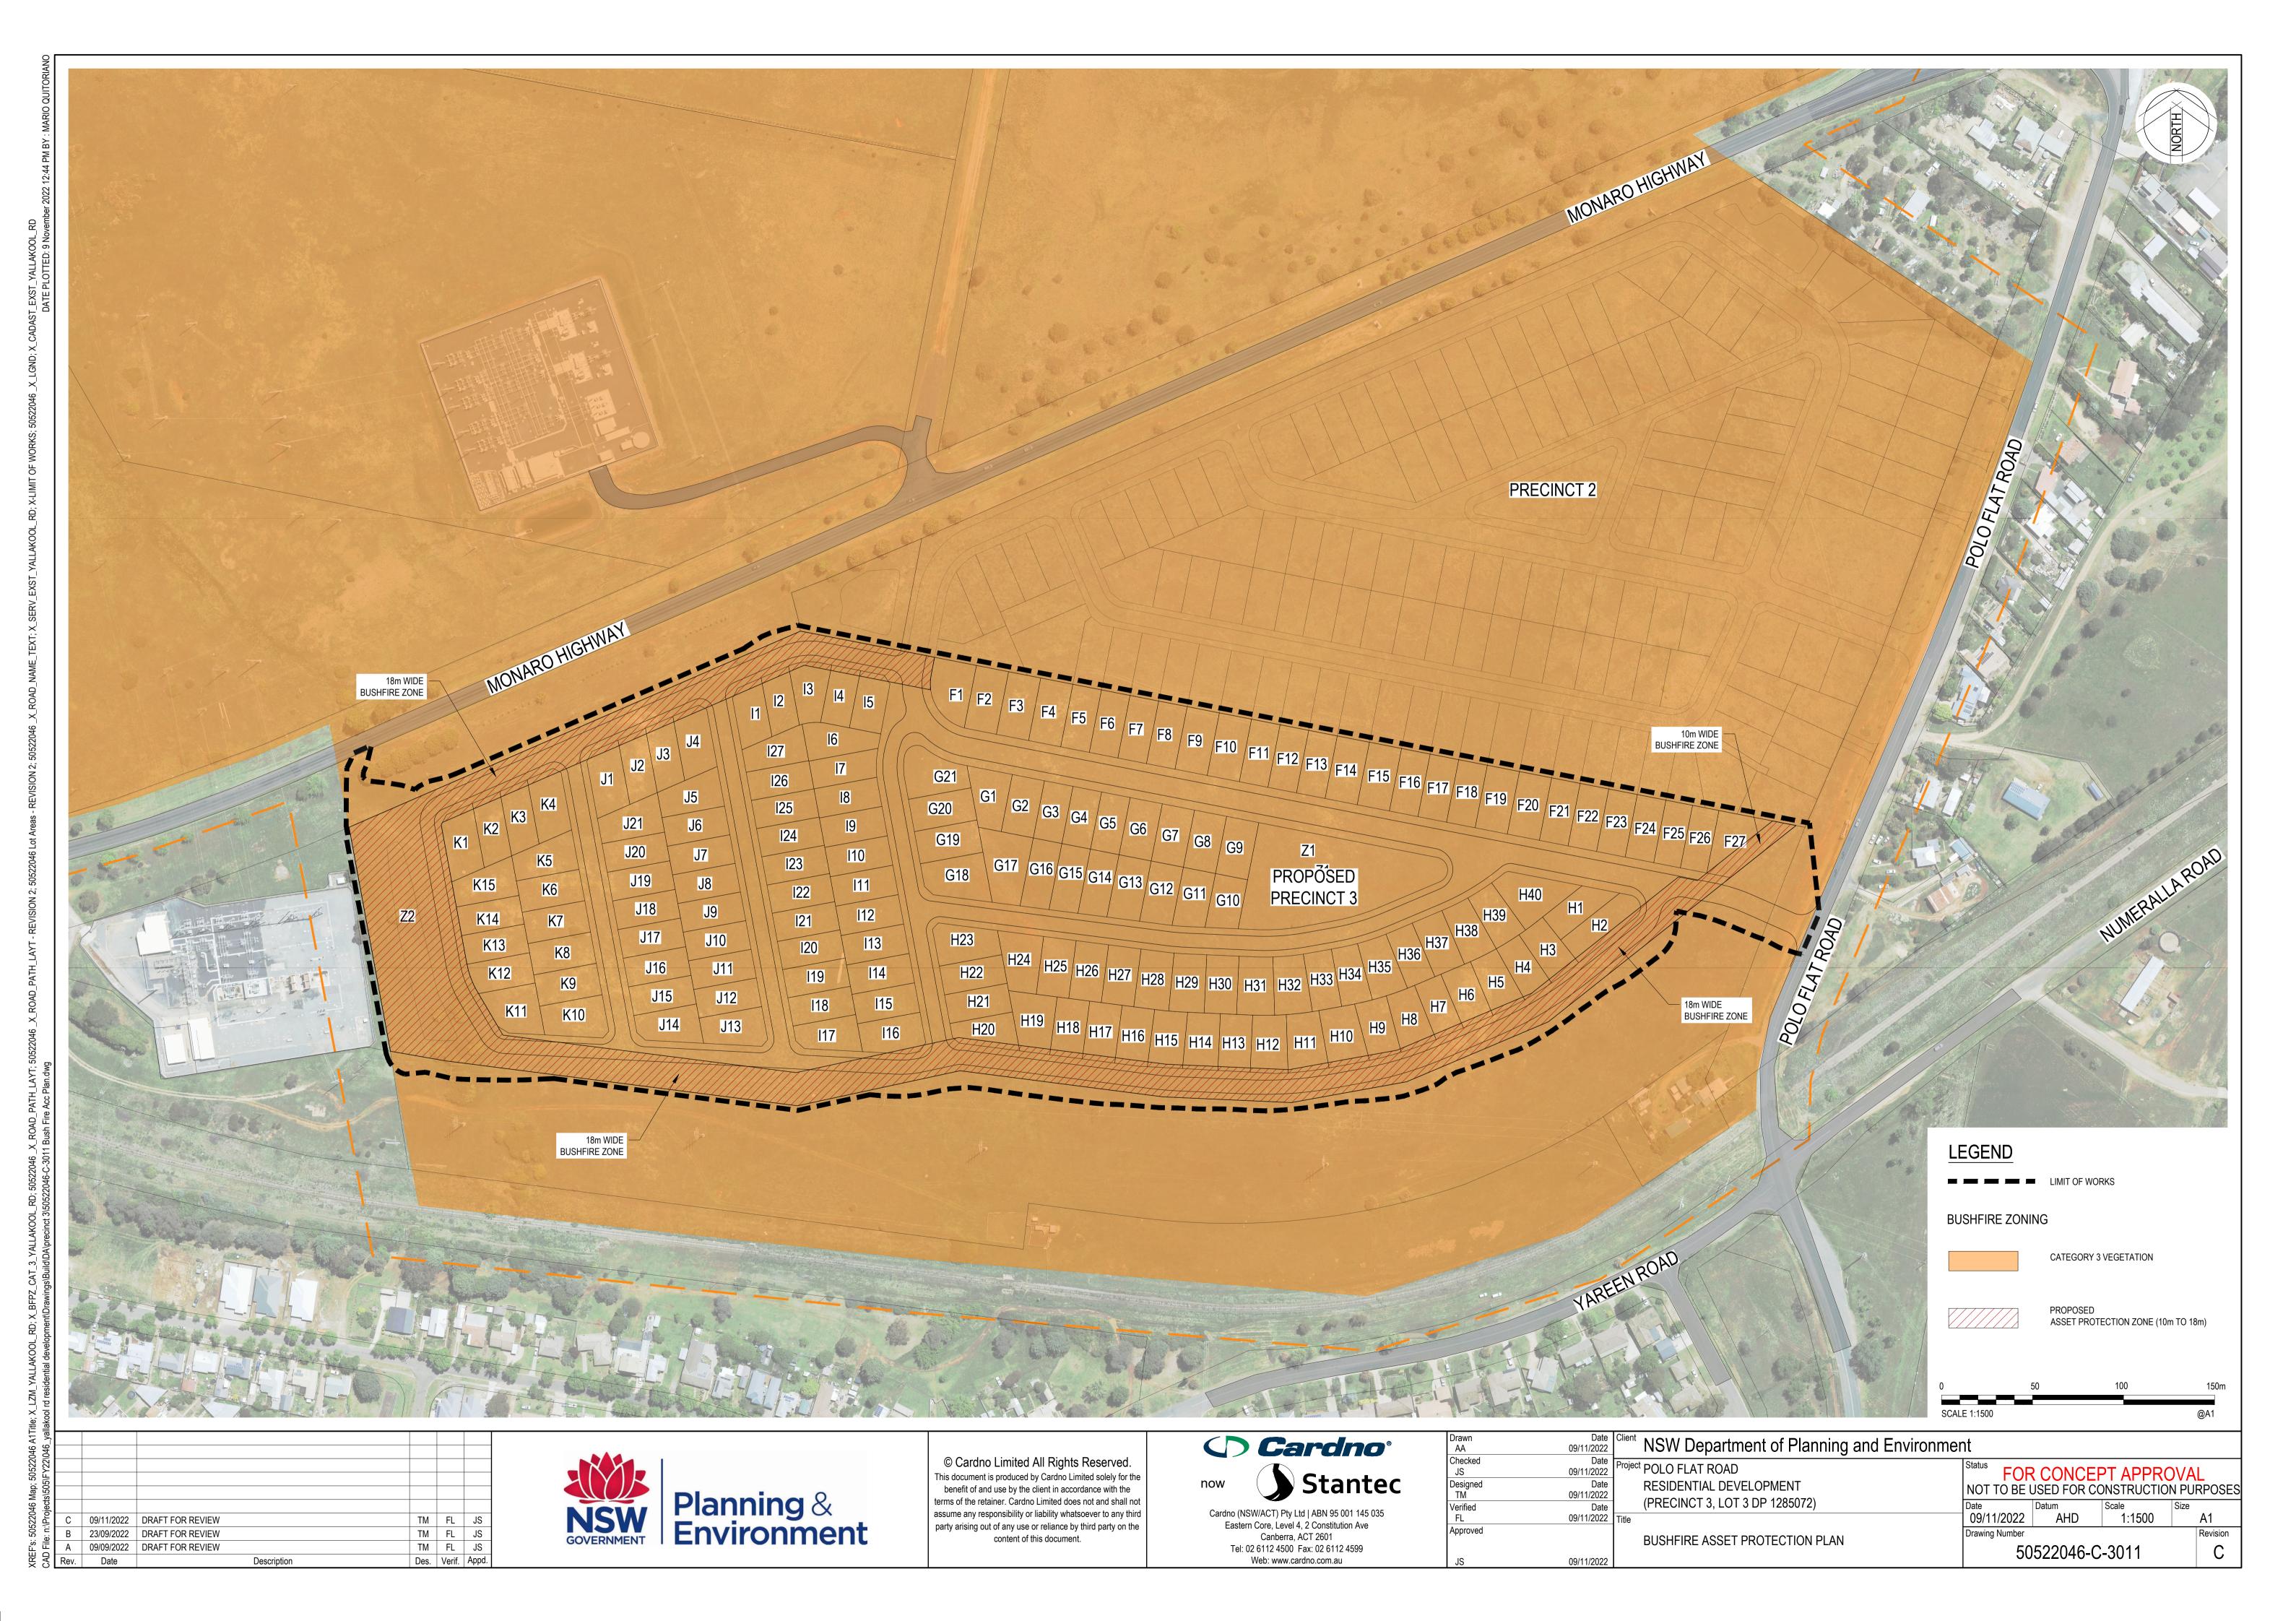
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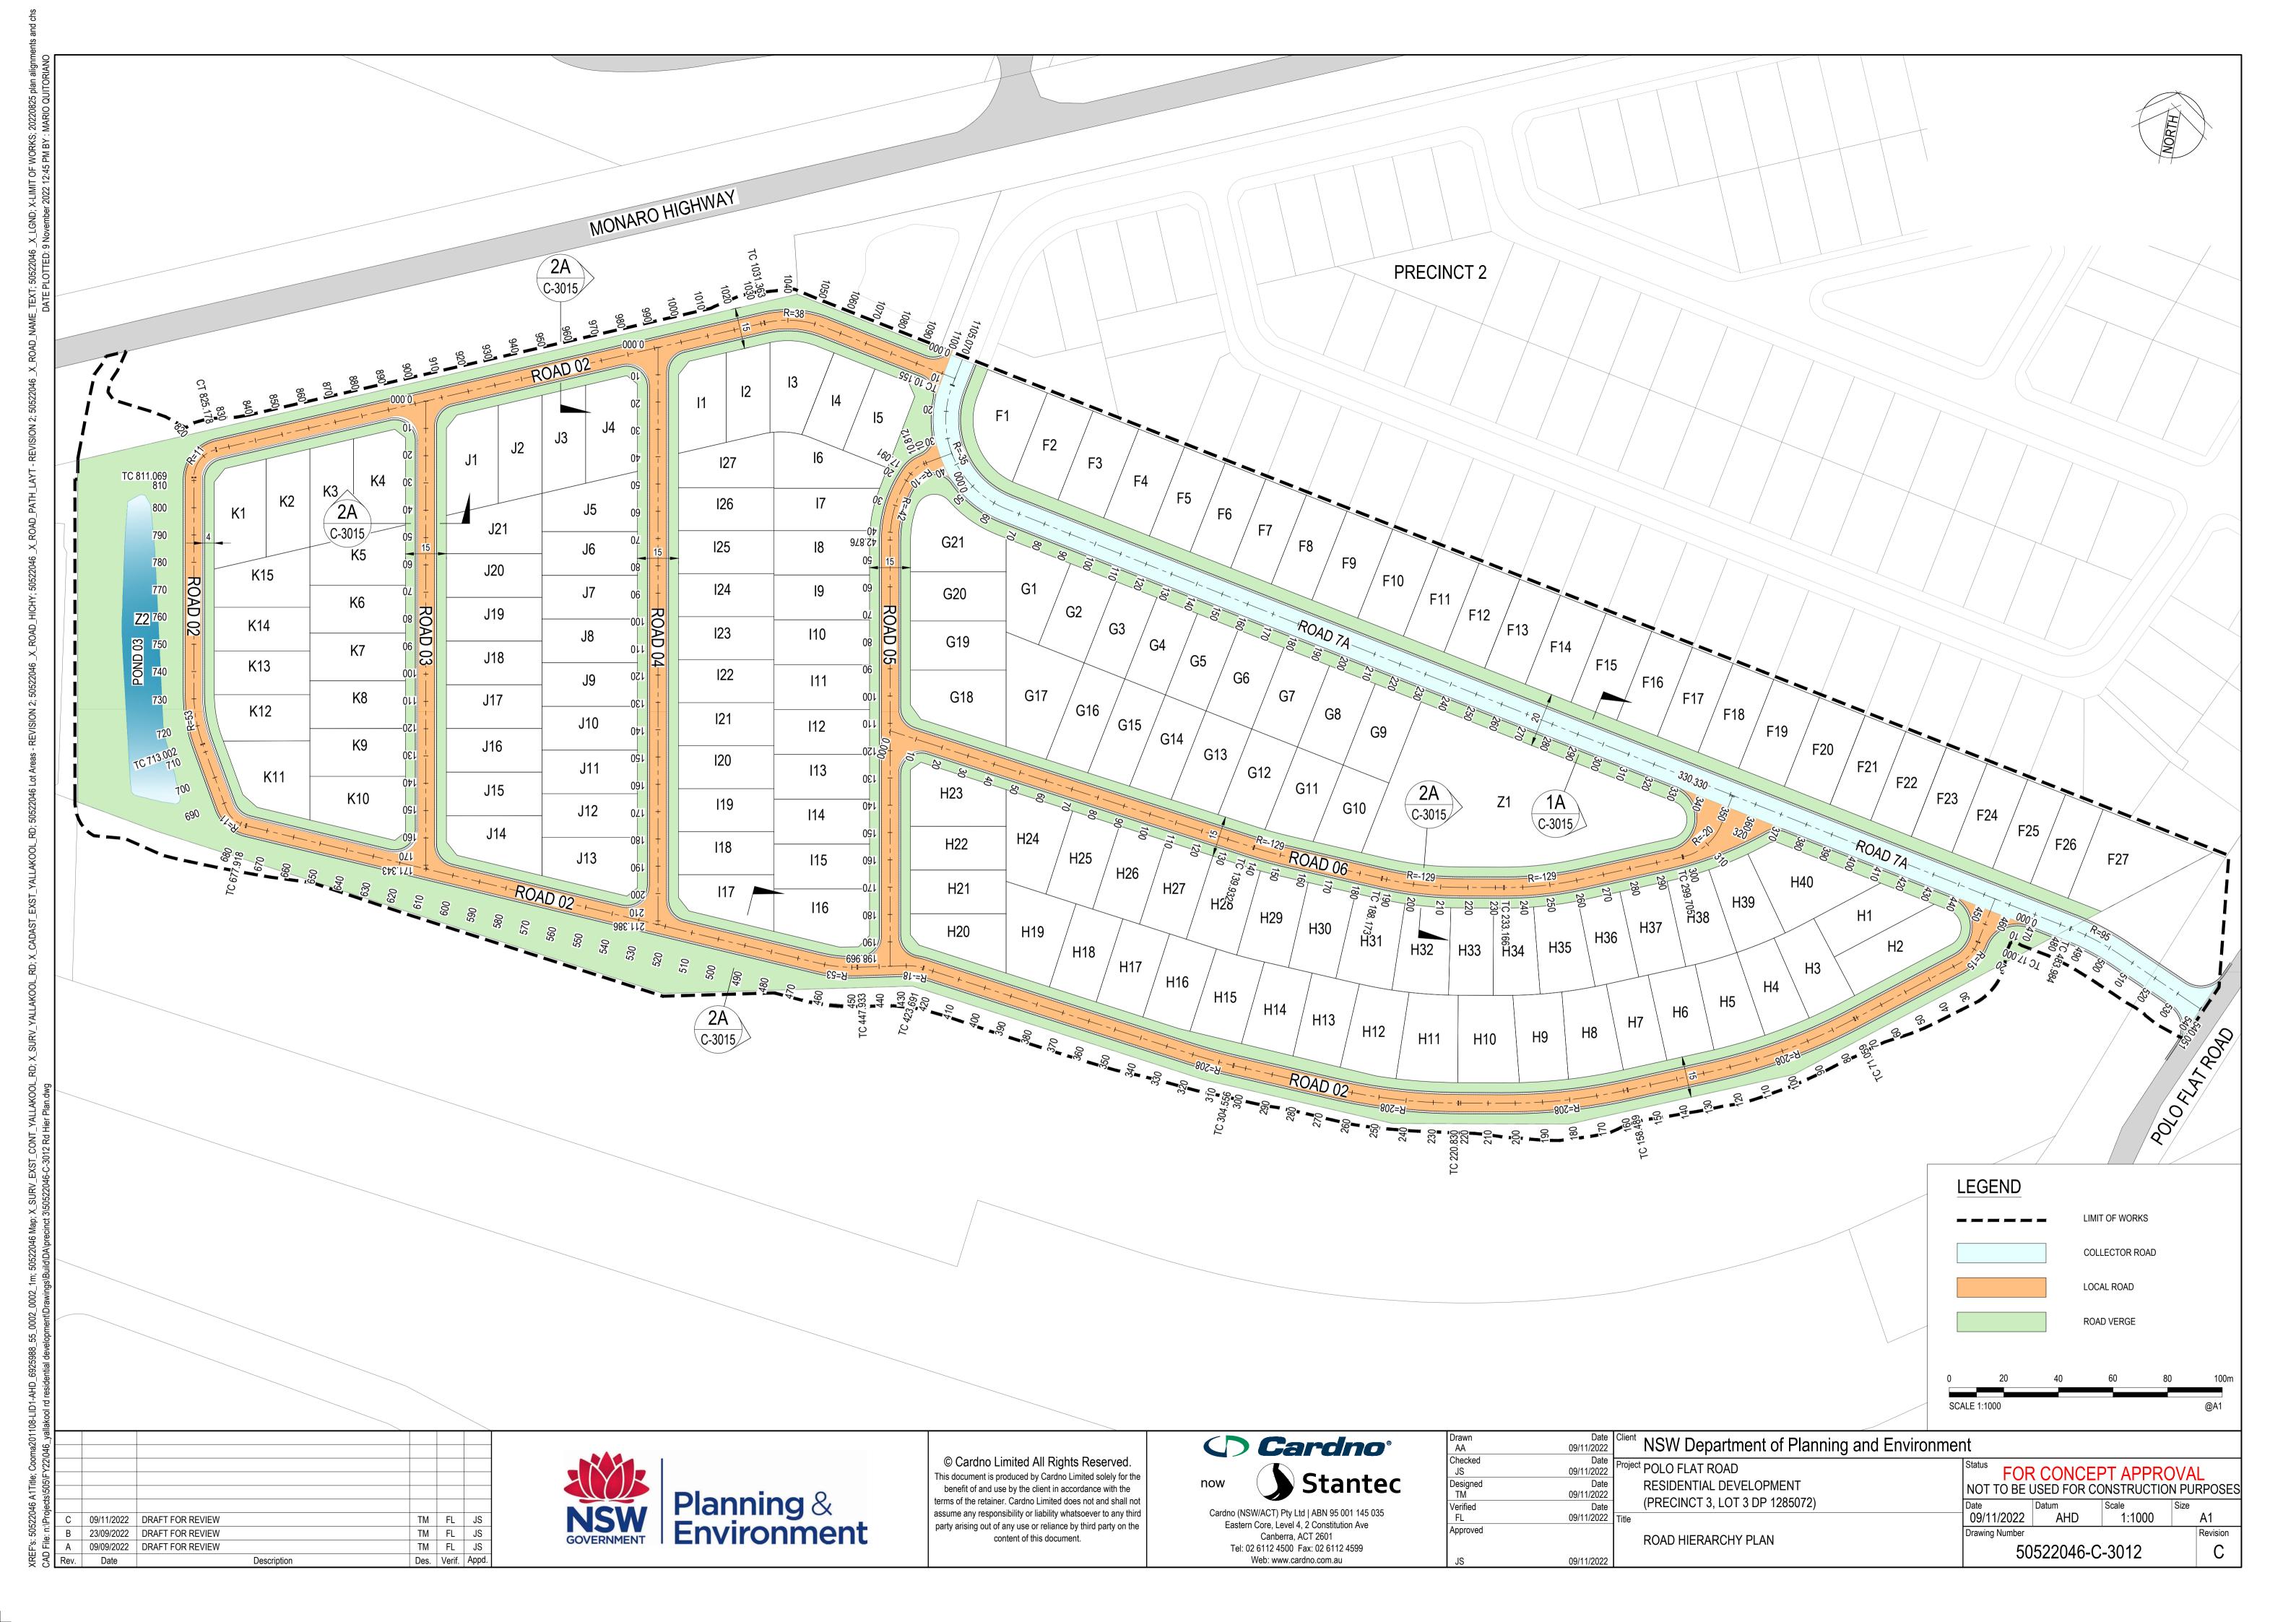
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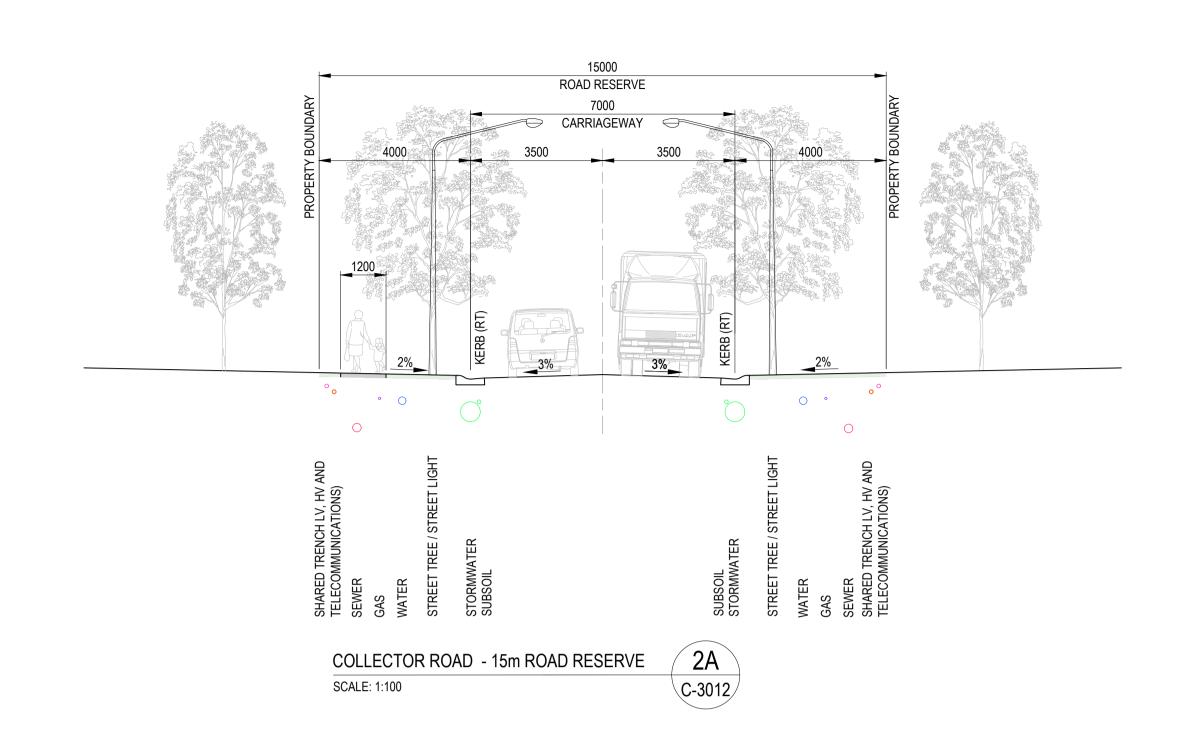
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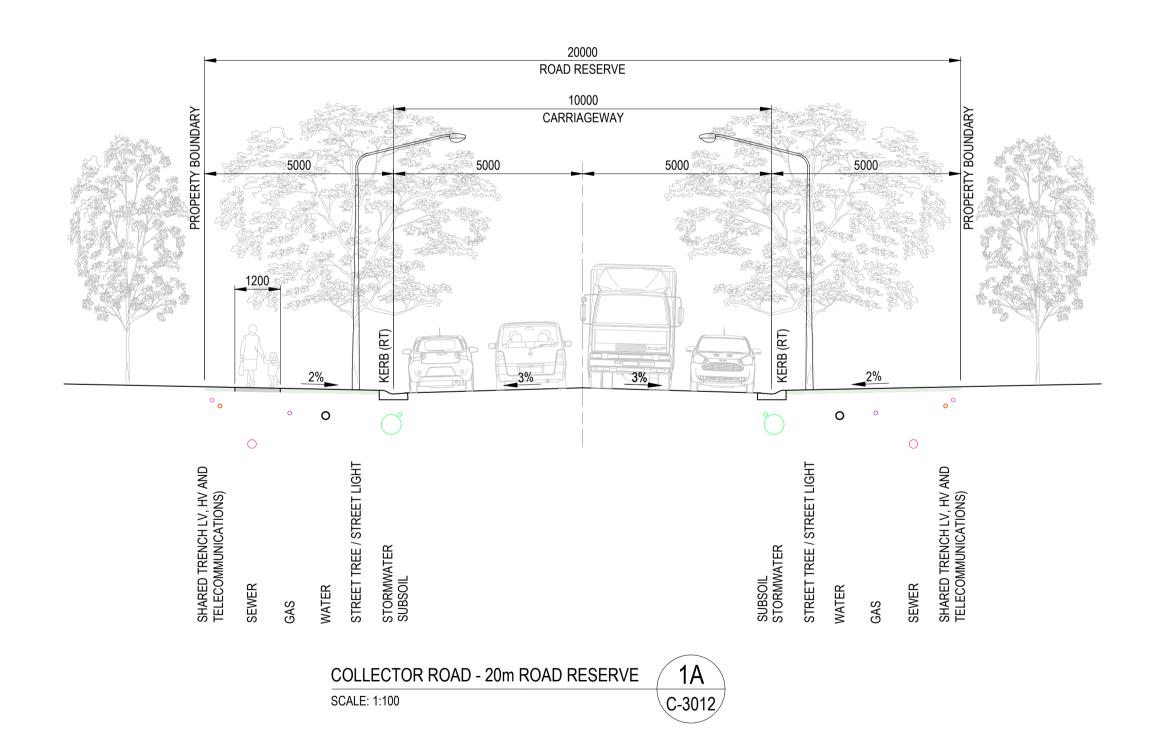












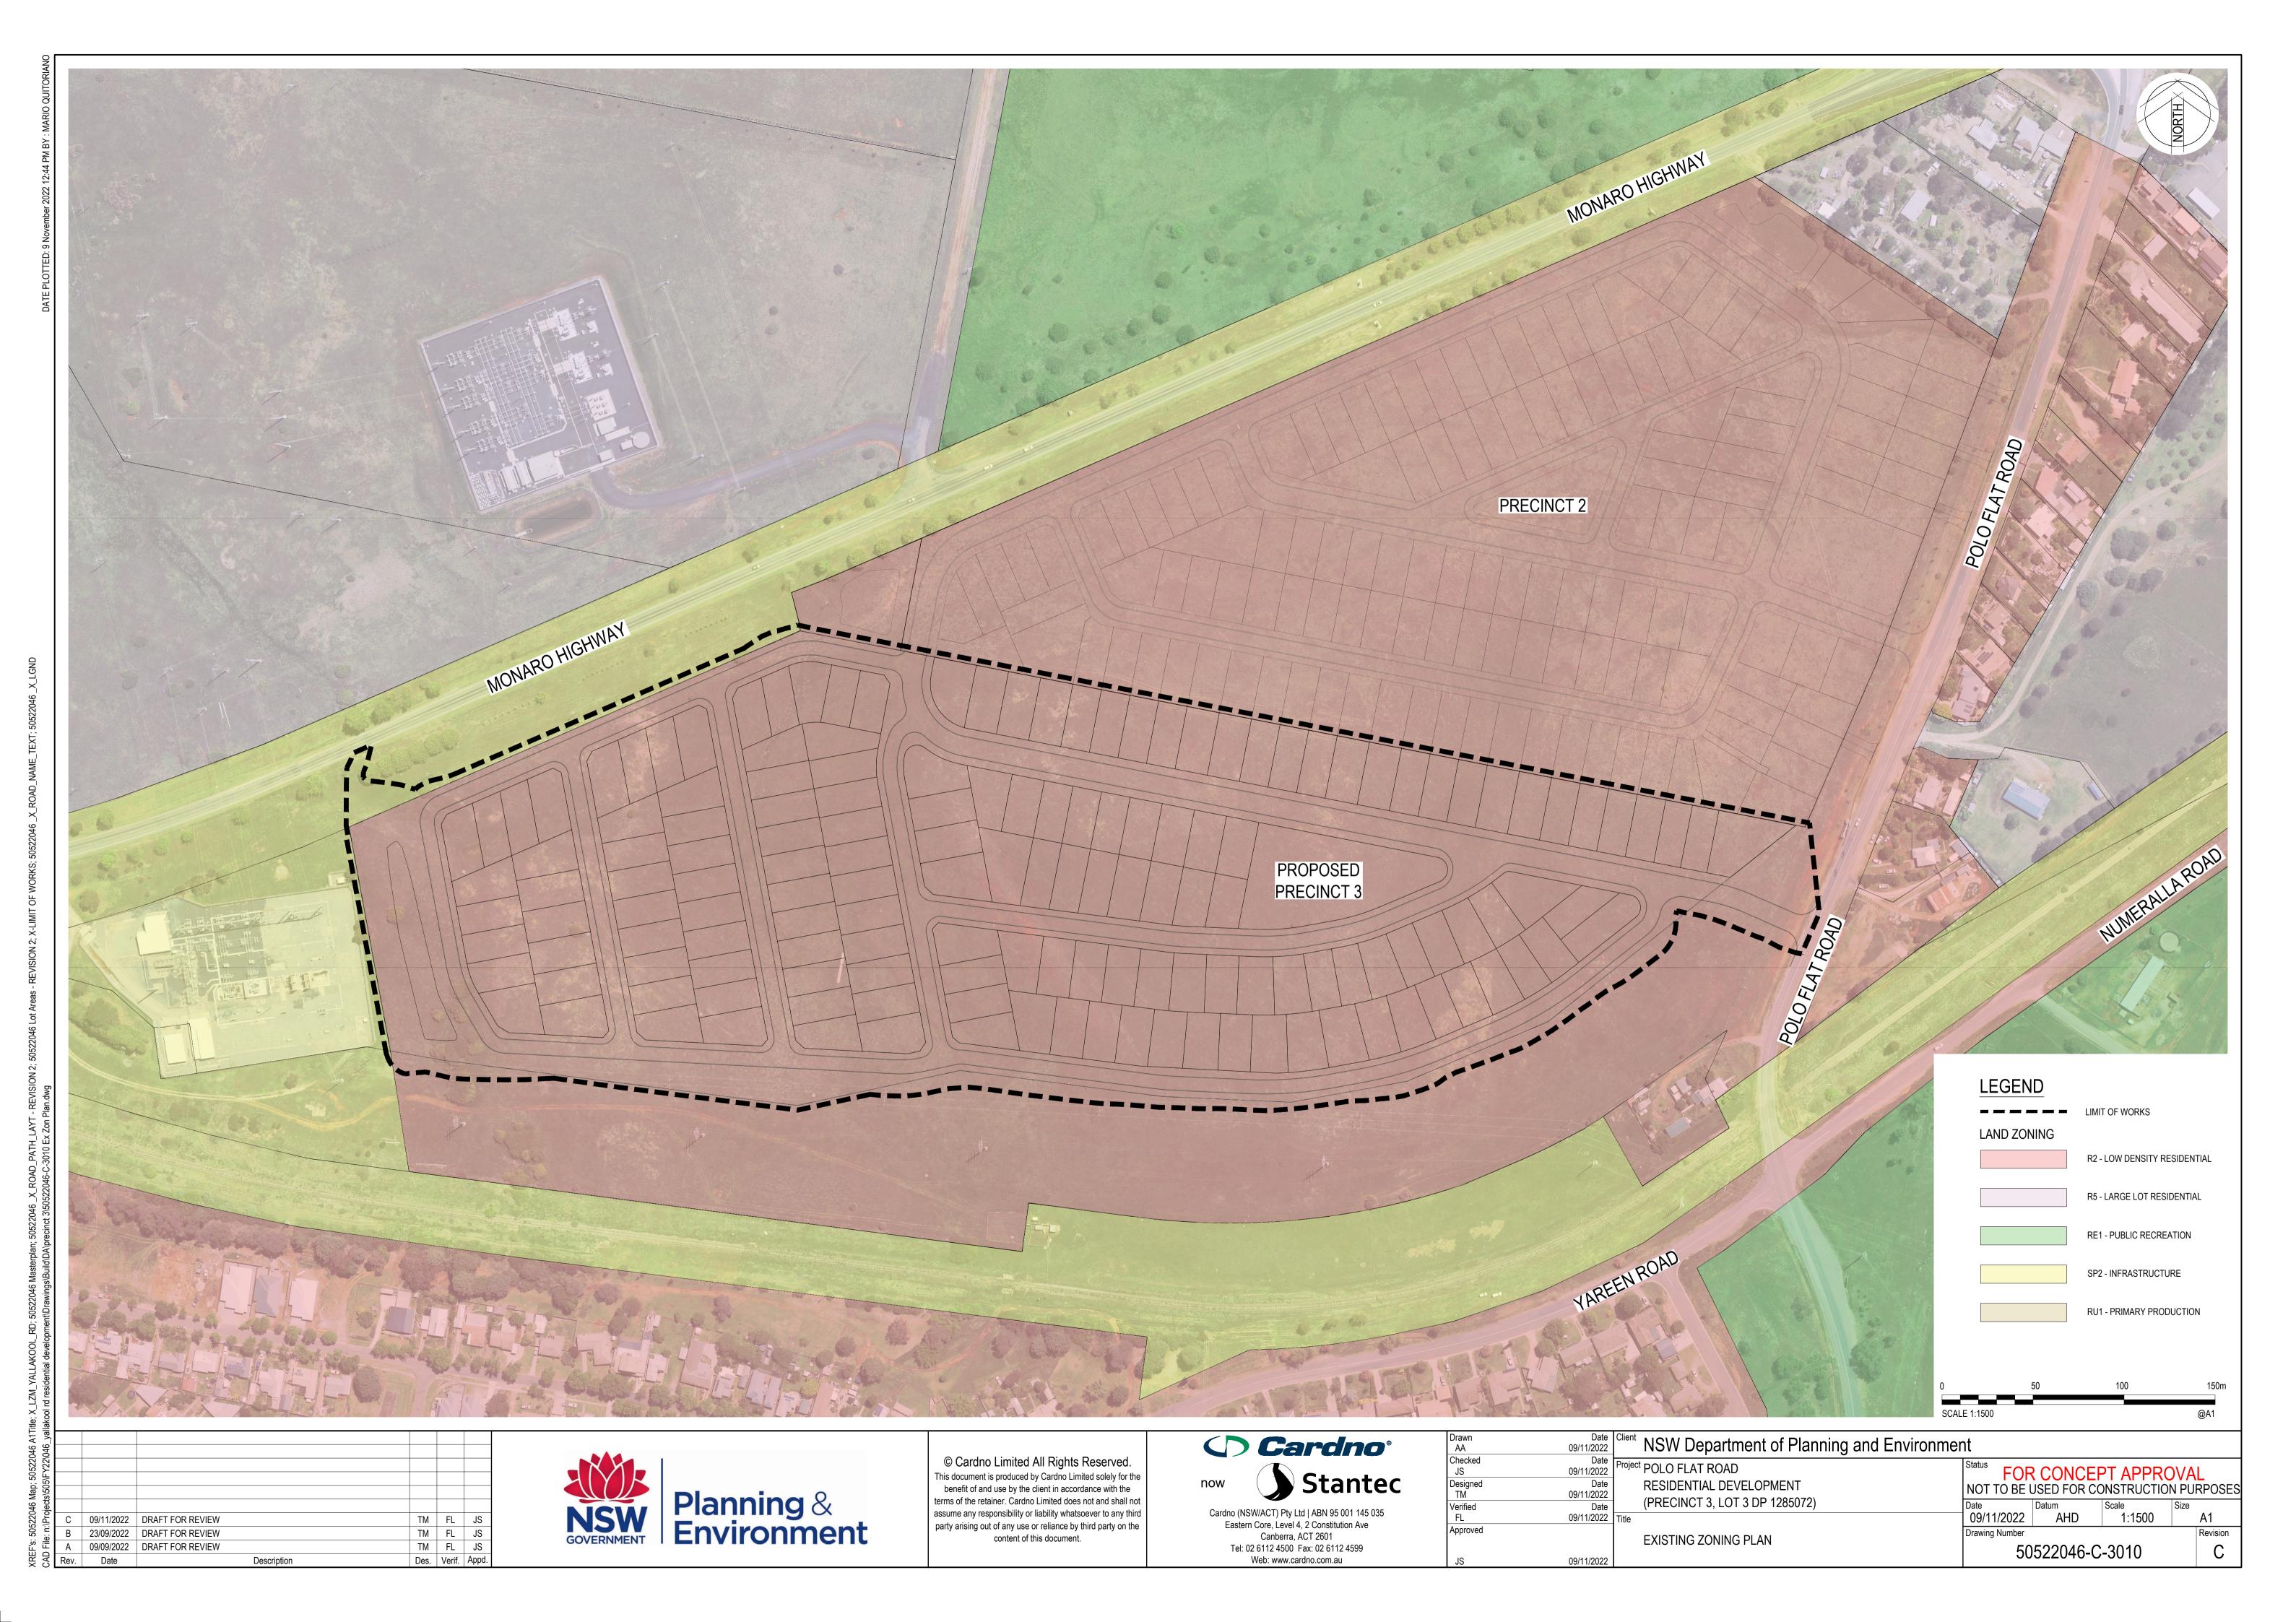

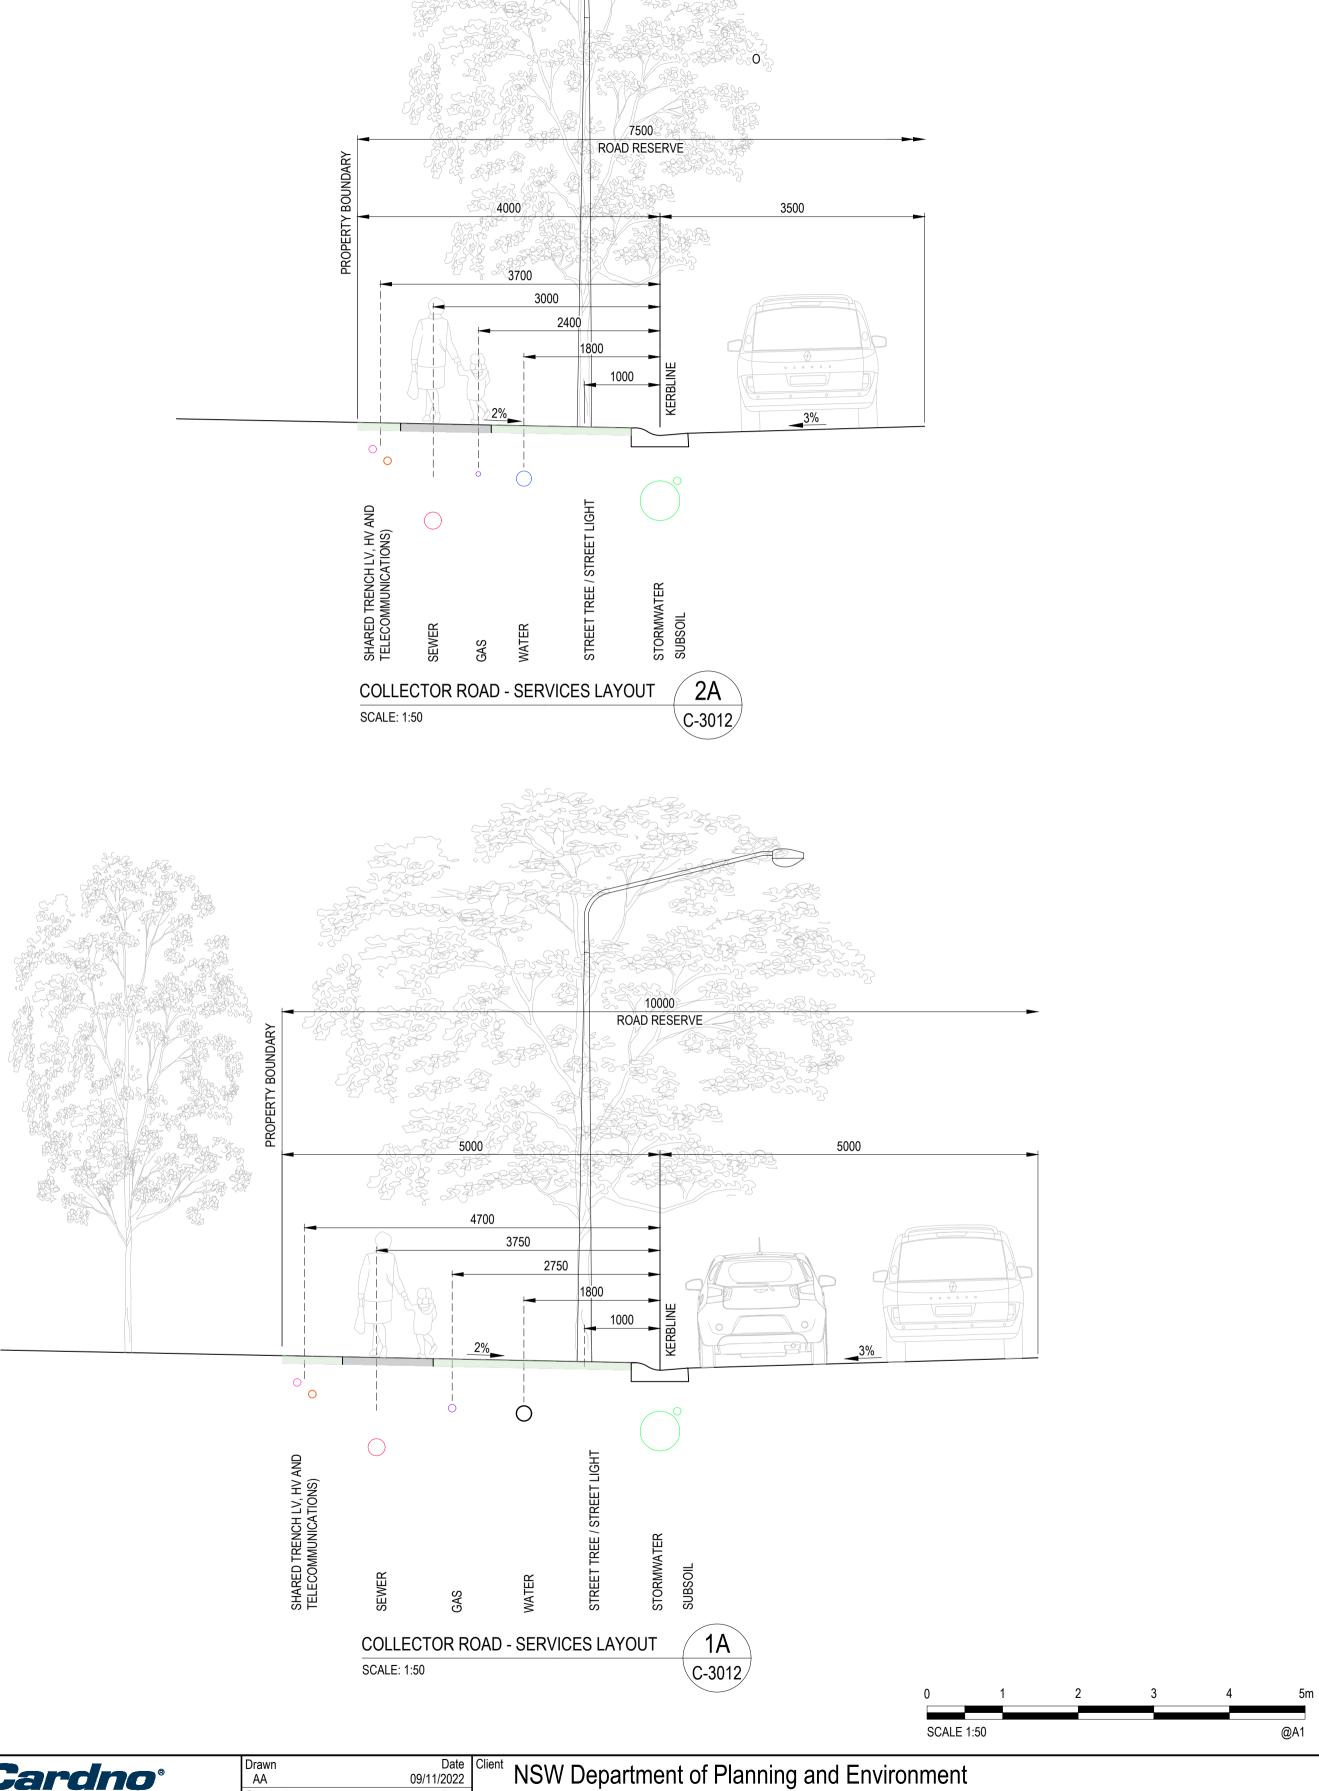

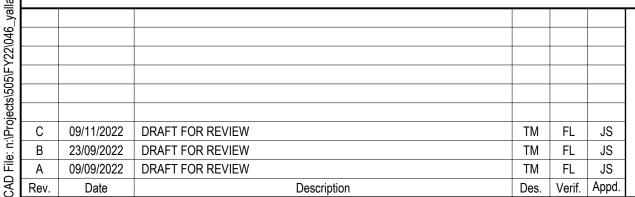





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VERTICAL GEOMETRY GRADE Datum RL805 FINISHED SURFACE **EXISTING SURFACE** CHAINAGE HORIZONTAL GEOMETRY LONGITUDINAL SECTION ROAD 02 SCALE 1:1000 HORI. SCALE 1:100 VERT.

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Planning & Environment

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Description

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Date

Date 09/11/2022 Project POLO FLAT ROAD RESIDENTIAL DEVELOPMENT (PRECINCT 3, LOT 3 DP 1285072)

Date 09/11/2022 Title ROAD LONG SECTIONS

Date ROAD CO

ROAD 02

SHEET 1 OF 2

FOR CONCEPT APPROVAL
NOT TO BE USED FOR CONSTRUCTION PURPOSES

Revision

Date Datum Scale Size O9/11/2022 AHD AS SHOWN A1

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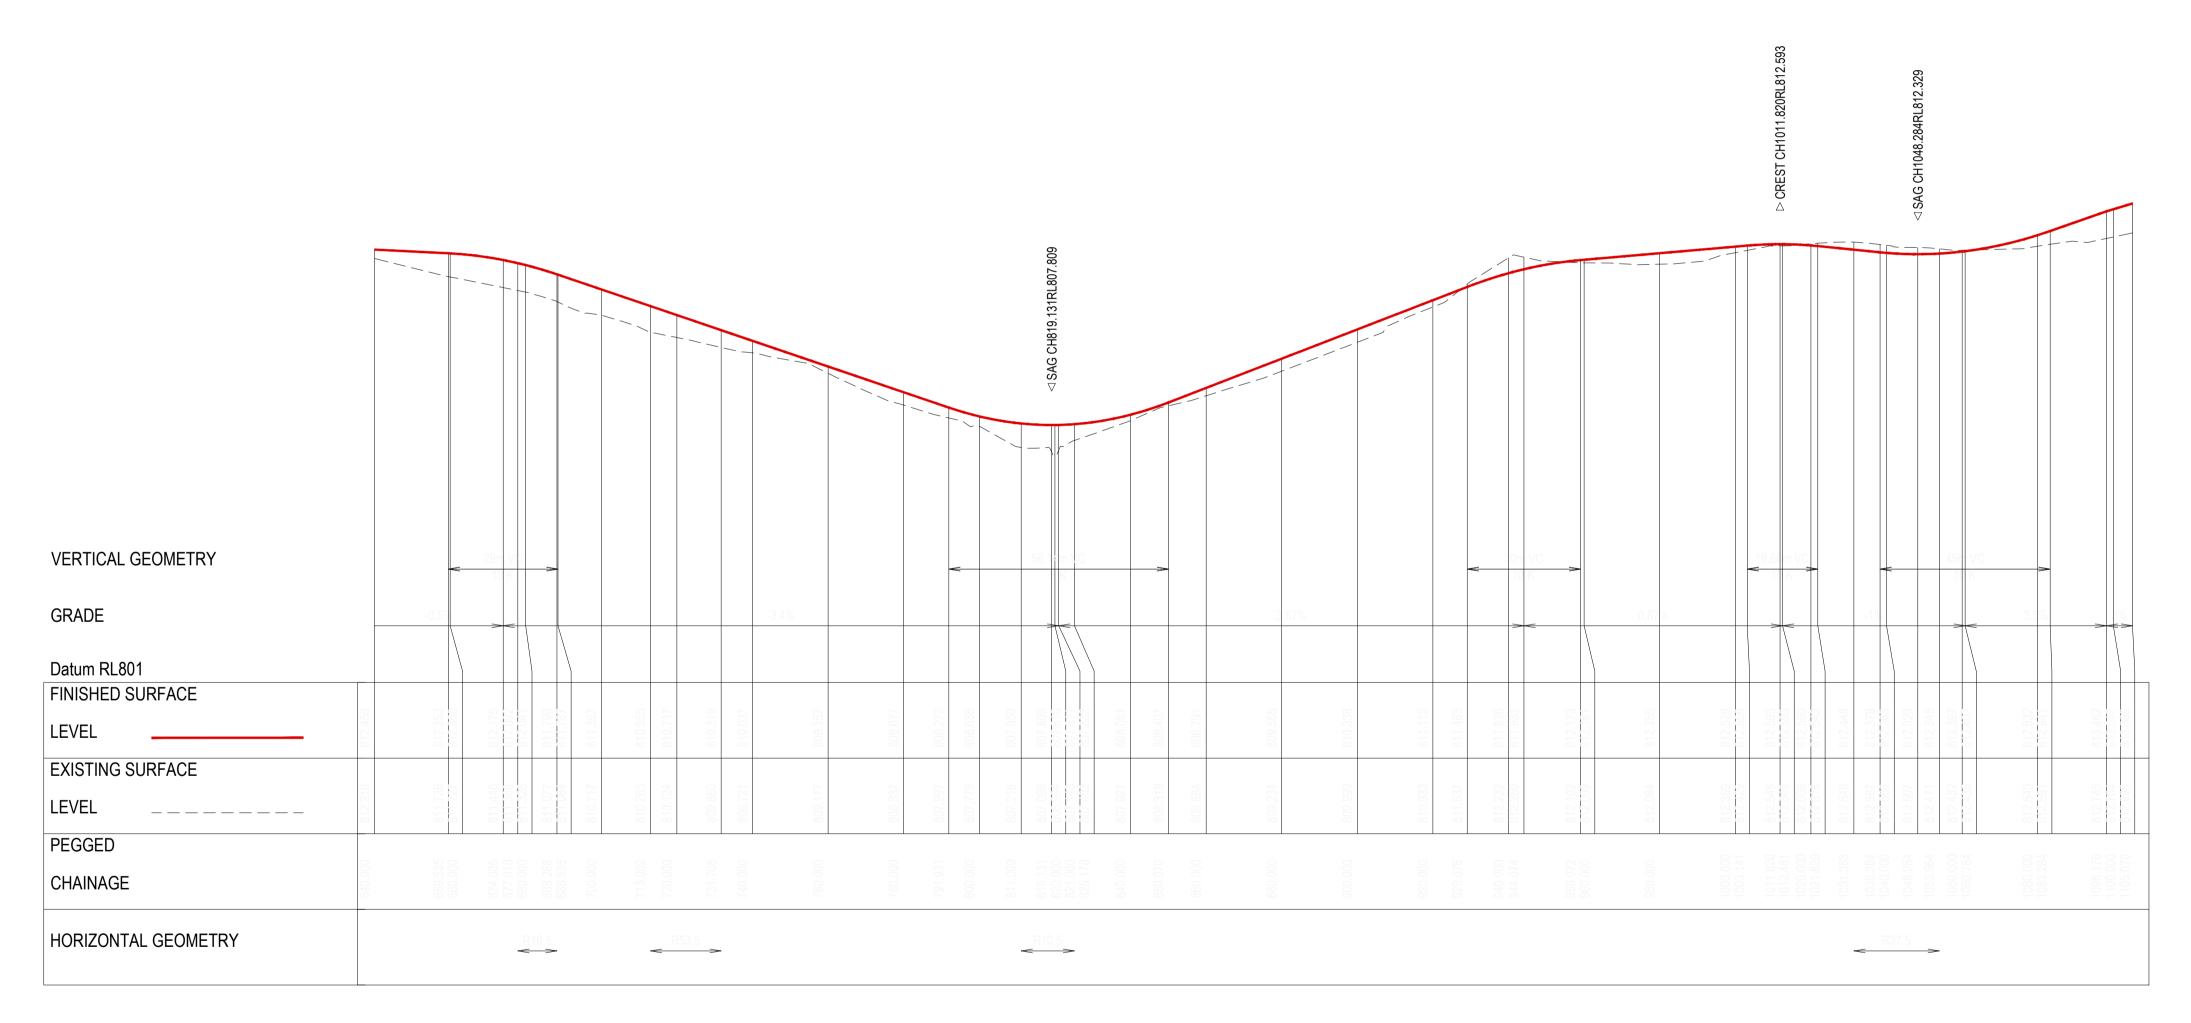
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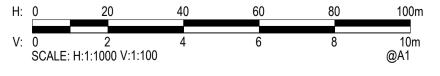
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LONGITUDINAL SECTION ROAD 02

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09/11/2022	ROAD 02 SHEET 2 OF 2	Drawing Number 50	)522046-C	3021	Revision	

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Description

Planning & Environment

VERTICAL GEOMETRY

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Datum RL805

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Project POLO FLAT ROAD FOR CONCEPT APPROVAL
NOT TO BE USED FOR CONSTRUCTION PURPOSES RESIDENTIAL DEVELOPMENT (PRECINCT 3, LOT 3 DP 1285072) 09/11/2022 AHD AS SHOWN A1 Title ROAD LONG SECTIONS Drawing Number ROAD 03, ROAD 04 AND ROAD 05 50522046-C-3022

Revision

LONGITUDINAL SECTION ROAD 05 SCALE 1:1000 HORI. SCALE 1:100 VERT.

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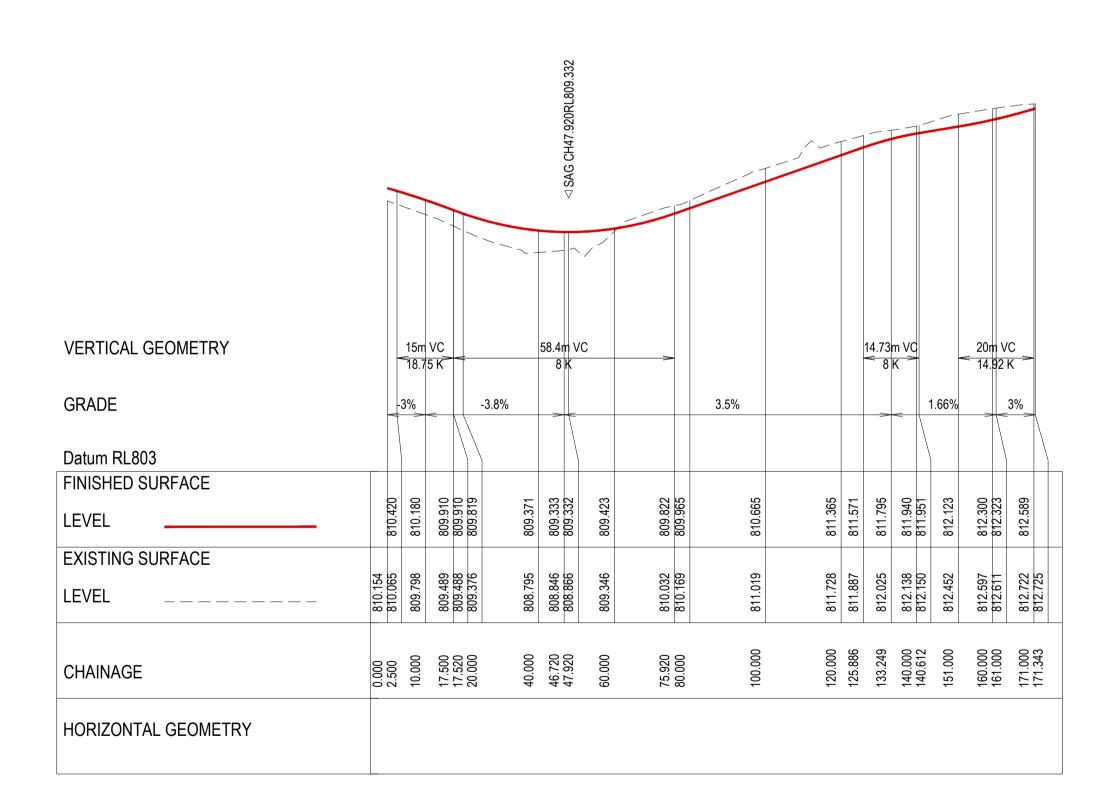
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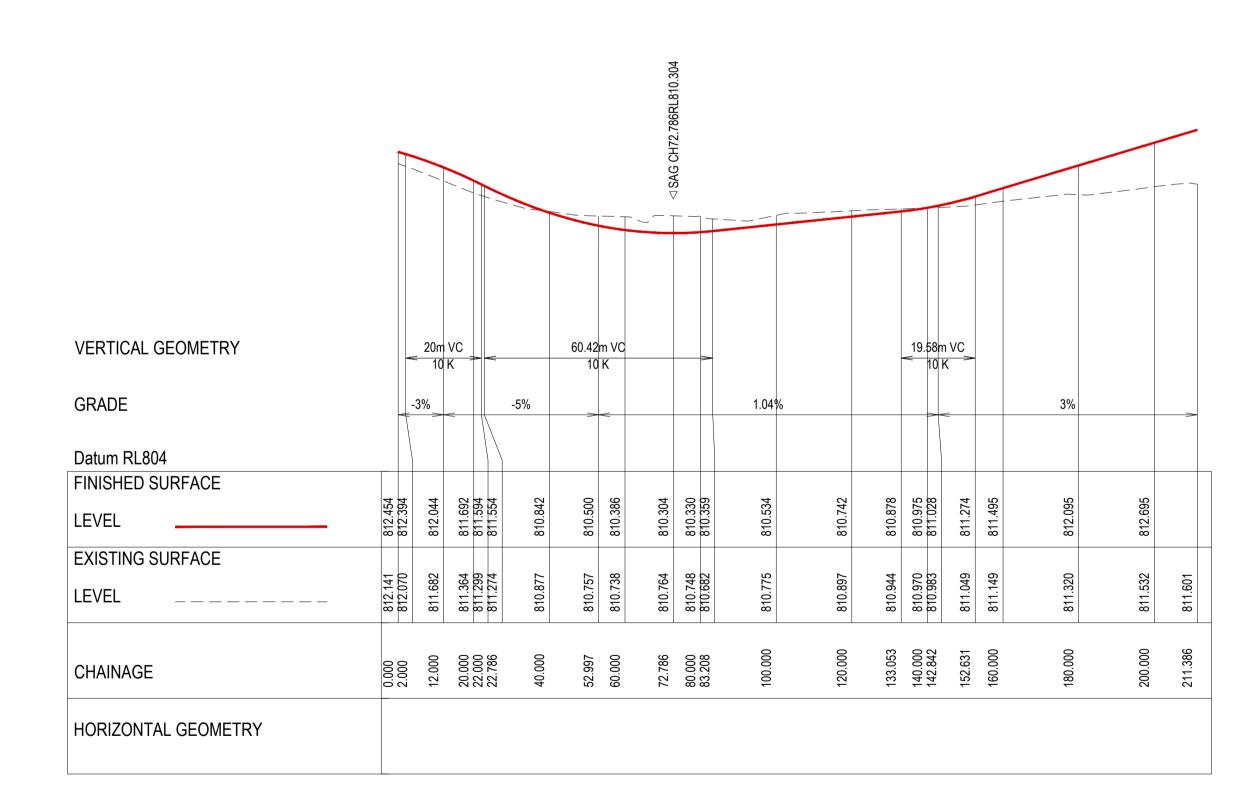
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LONGITUDINAL SECTION ROAD 03 SCALE 1:1000 HORI. SCALE 1:100 VERT.



## LONGITUDINAL SECTION ROAD 04 SCALE 1:1000 HORI. SCALE 1:100 VERT.

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VERTICAL GEOMETRY GRADE Datum RL805 FINISHED SURFACE LEVEL **EXISTING SURFACE** LEVEL CHAINAGE HORIZONTAL GEOMETRY

LONGITUDINAL SECTION ROAD 06

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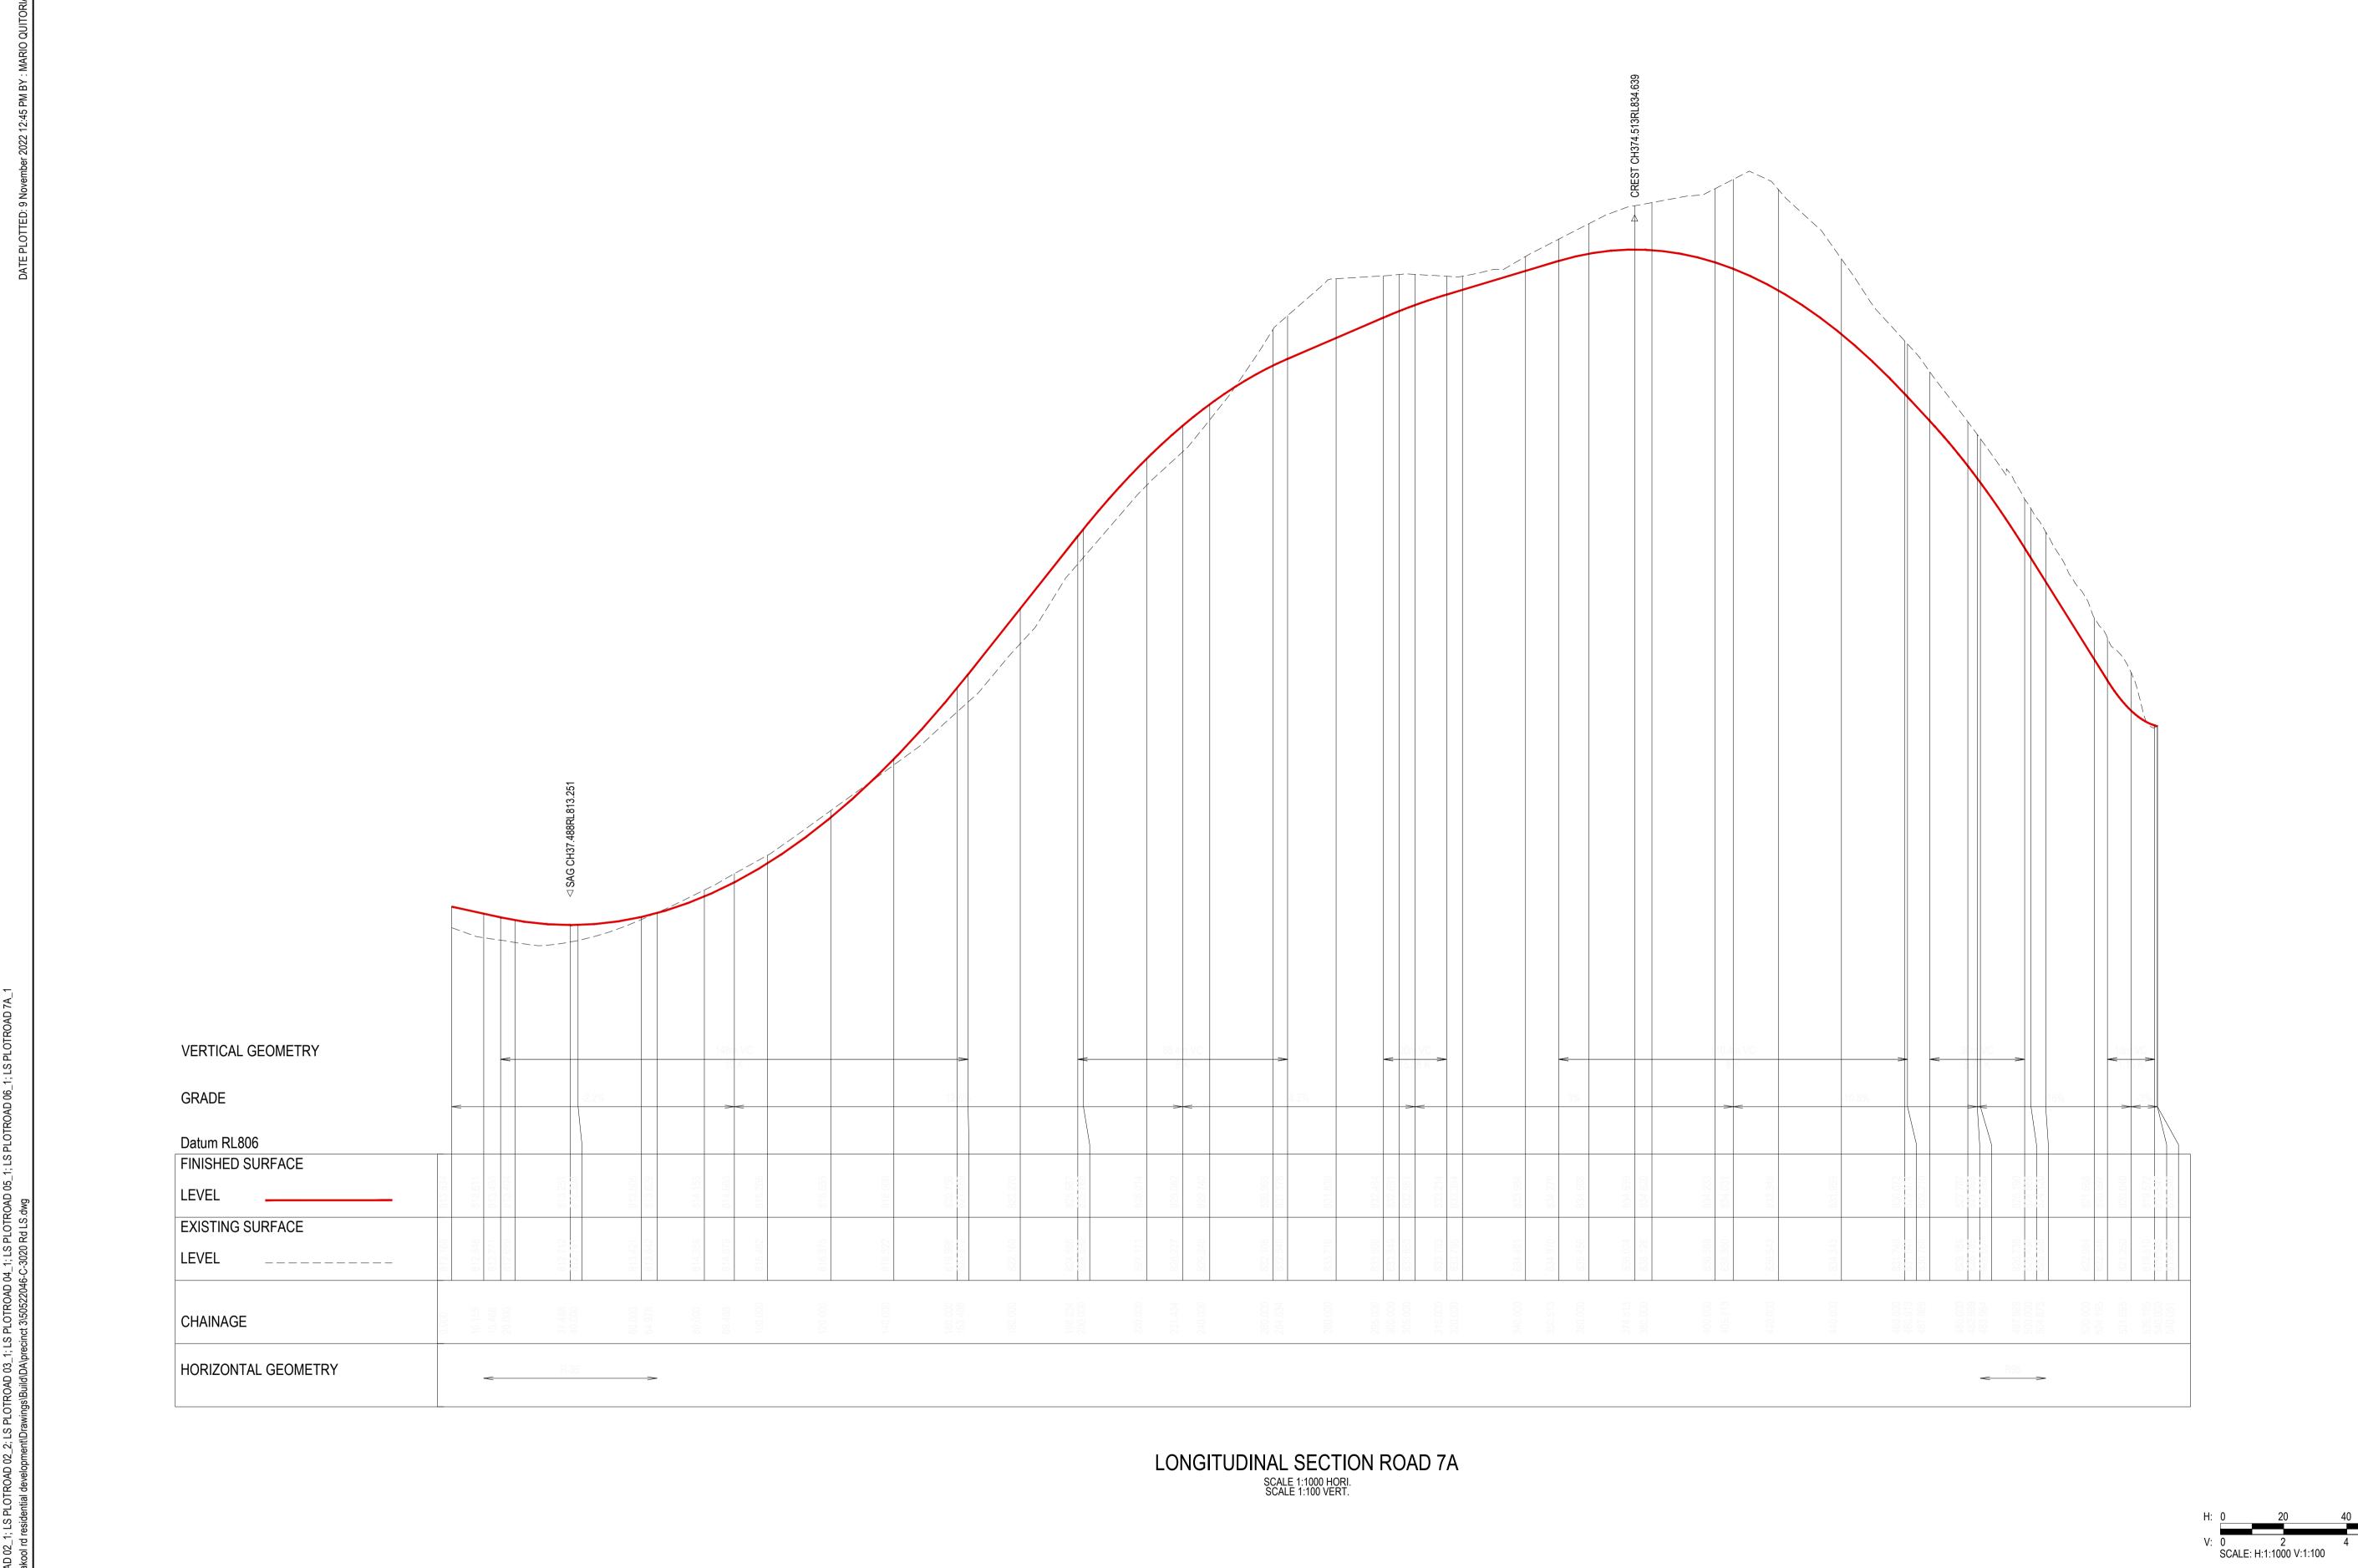
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o (NSW/ACT) Pty Ltd   ABN 95 001 145 035	Verified FL
stern Core, Level 4, 2 Constitution Ave Canberra, ACT 2601	Approved
Fel: 02 6112 4500 Fax: 02 6112 4599	
Web: www.cardno.com.au	JS

09/11/2022	NSW Department of Planning and Envi	ironment	
Date 09/11/2022 Date 09/11/2022	Project POLO FLAT ROAD RESIDENTIAL DEVELOPMENT	FOR CONCEPT APPROVAL NOT TO BE USED FOR CONSTRUCTION PURPOSE	-S
Date 09/11/2022	(PRECINCT 3, LOT 3 DP 1285072)  Title ROAD LONG SECTIONS	Date	
	ROAD 06	Drawing Number Revision	
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Planning & Environment

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Tel: 02 6112 4500 Fax: 02 6112 4599
Web: www.cardno.com.au

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Client NSW Department of Planning and Environmen	nt
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(PRECINCT 3, LOT 3 DP 1285072)	Date

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(PRECINCT 3, LOT 3 DP 1285072)	Date	Datum	Scale	Size			
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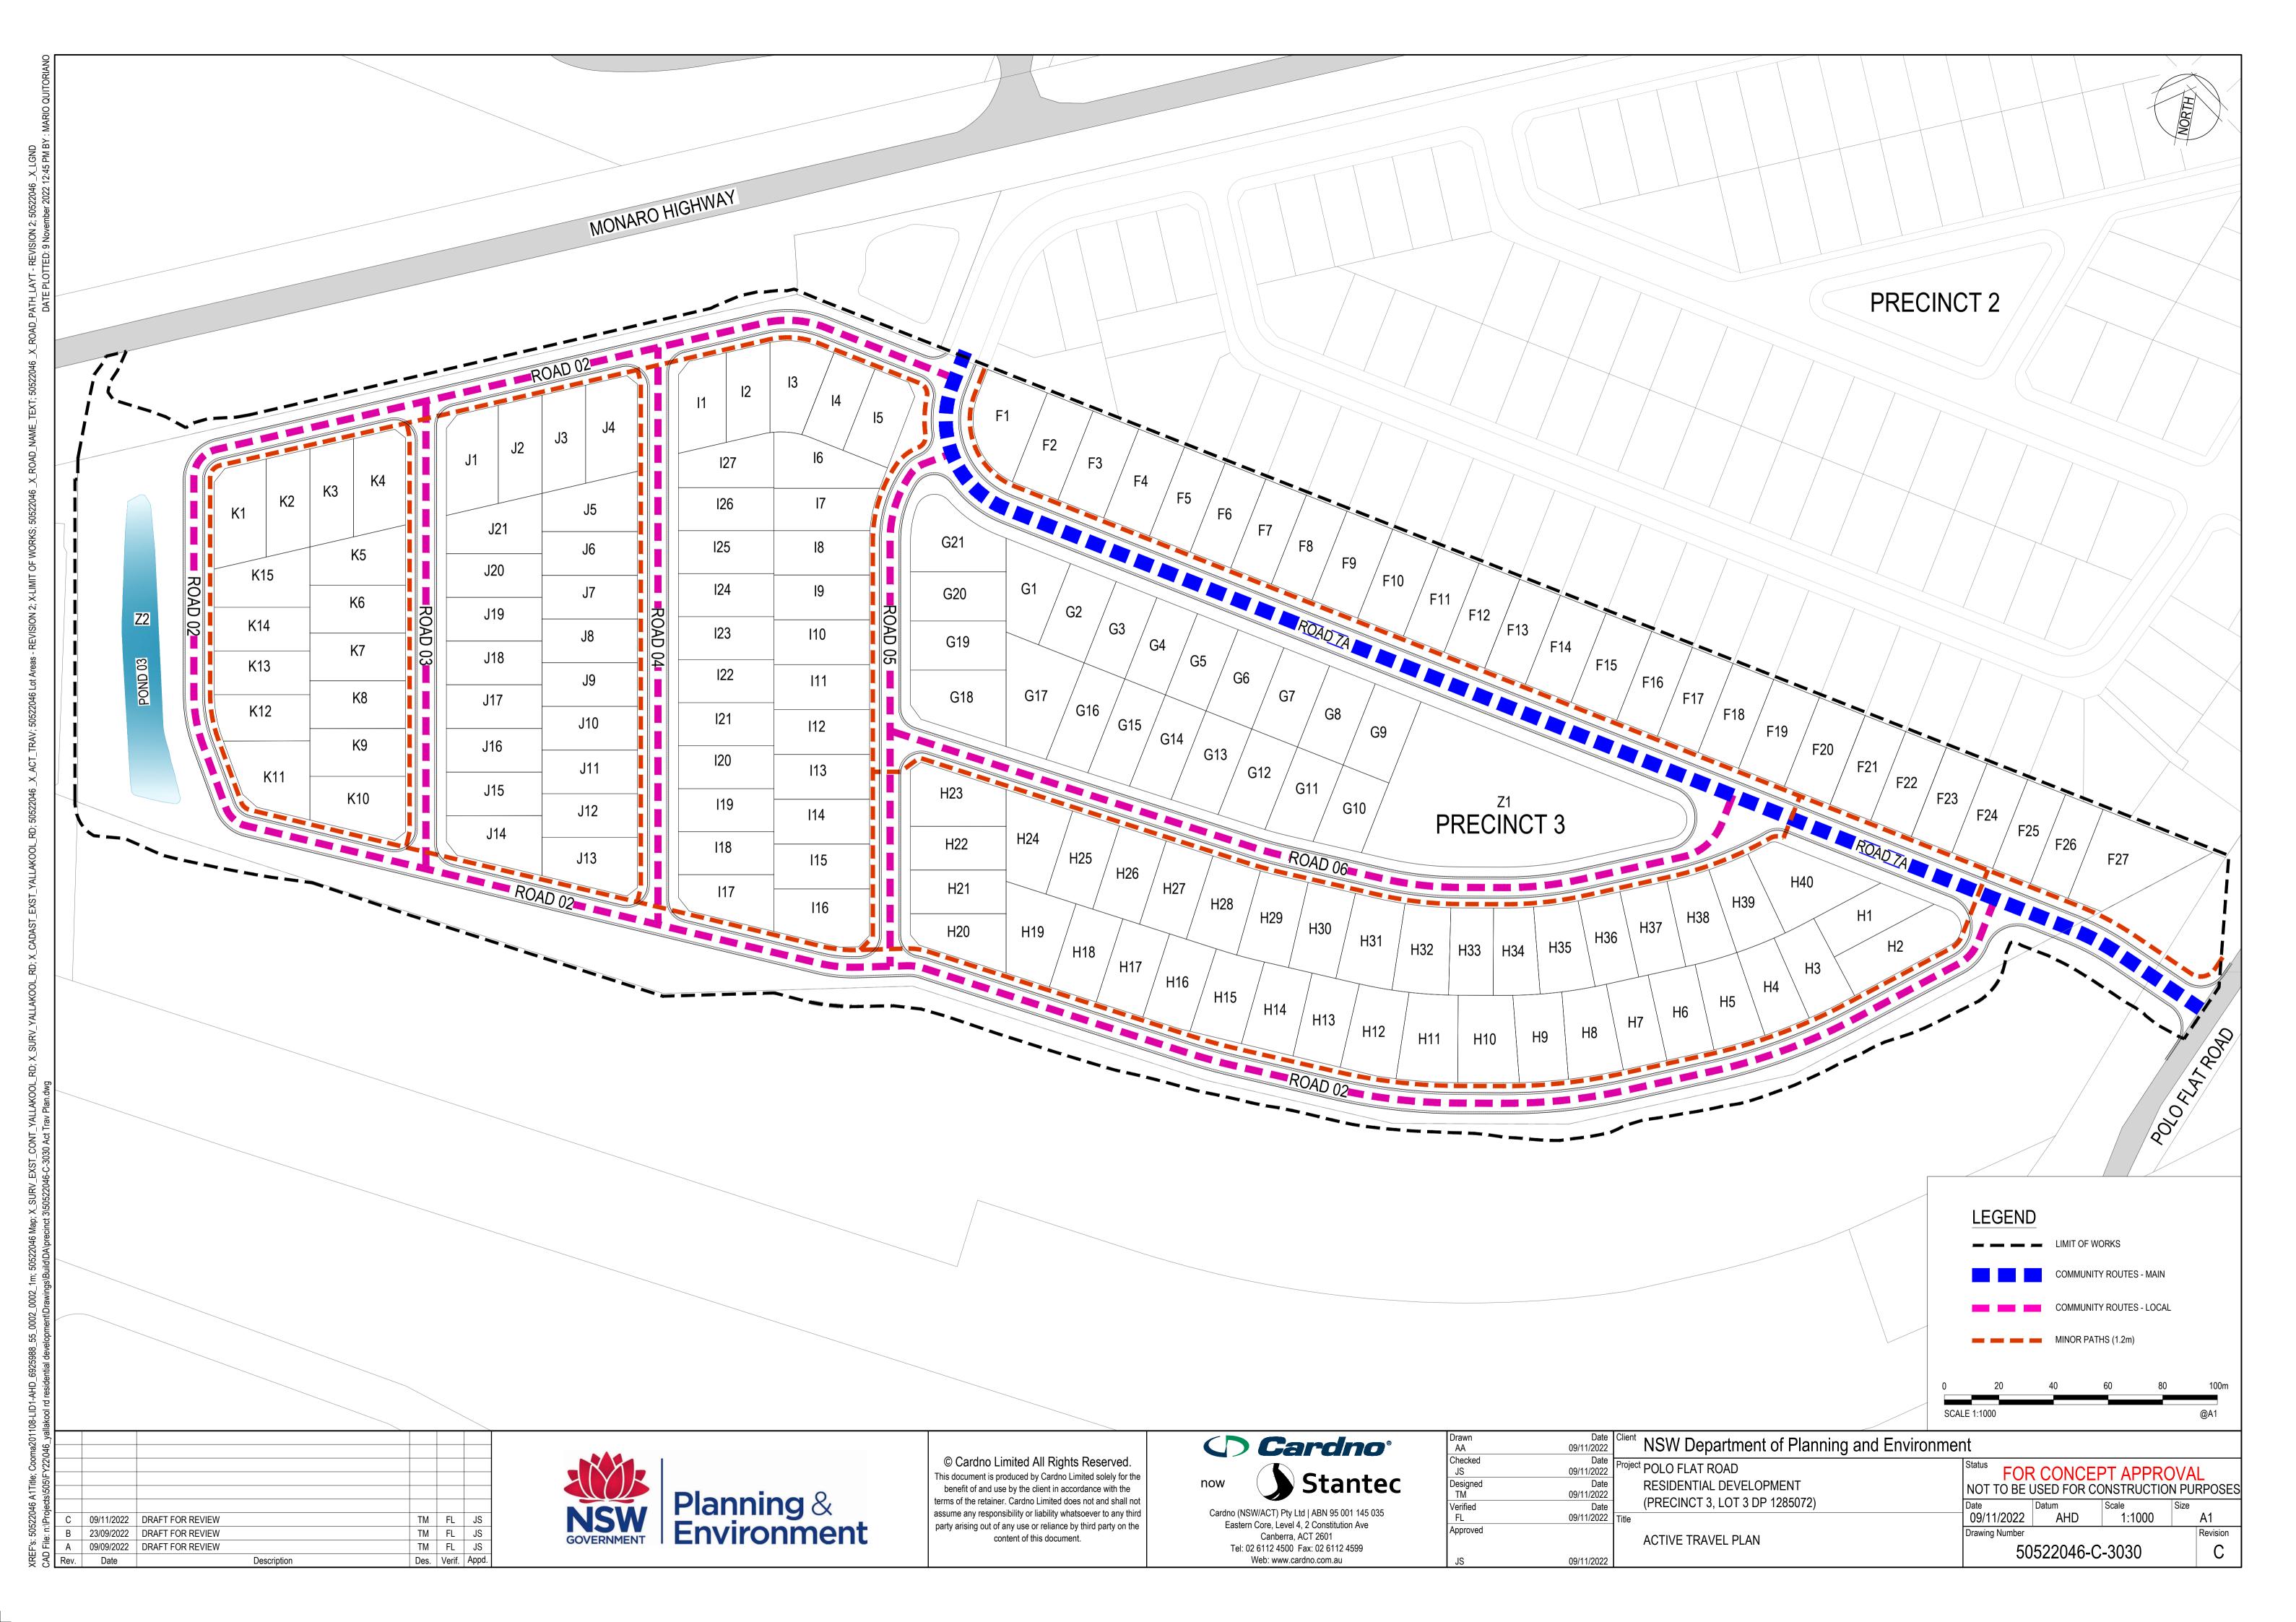
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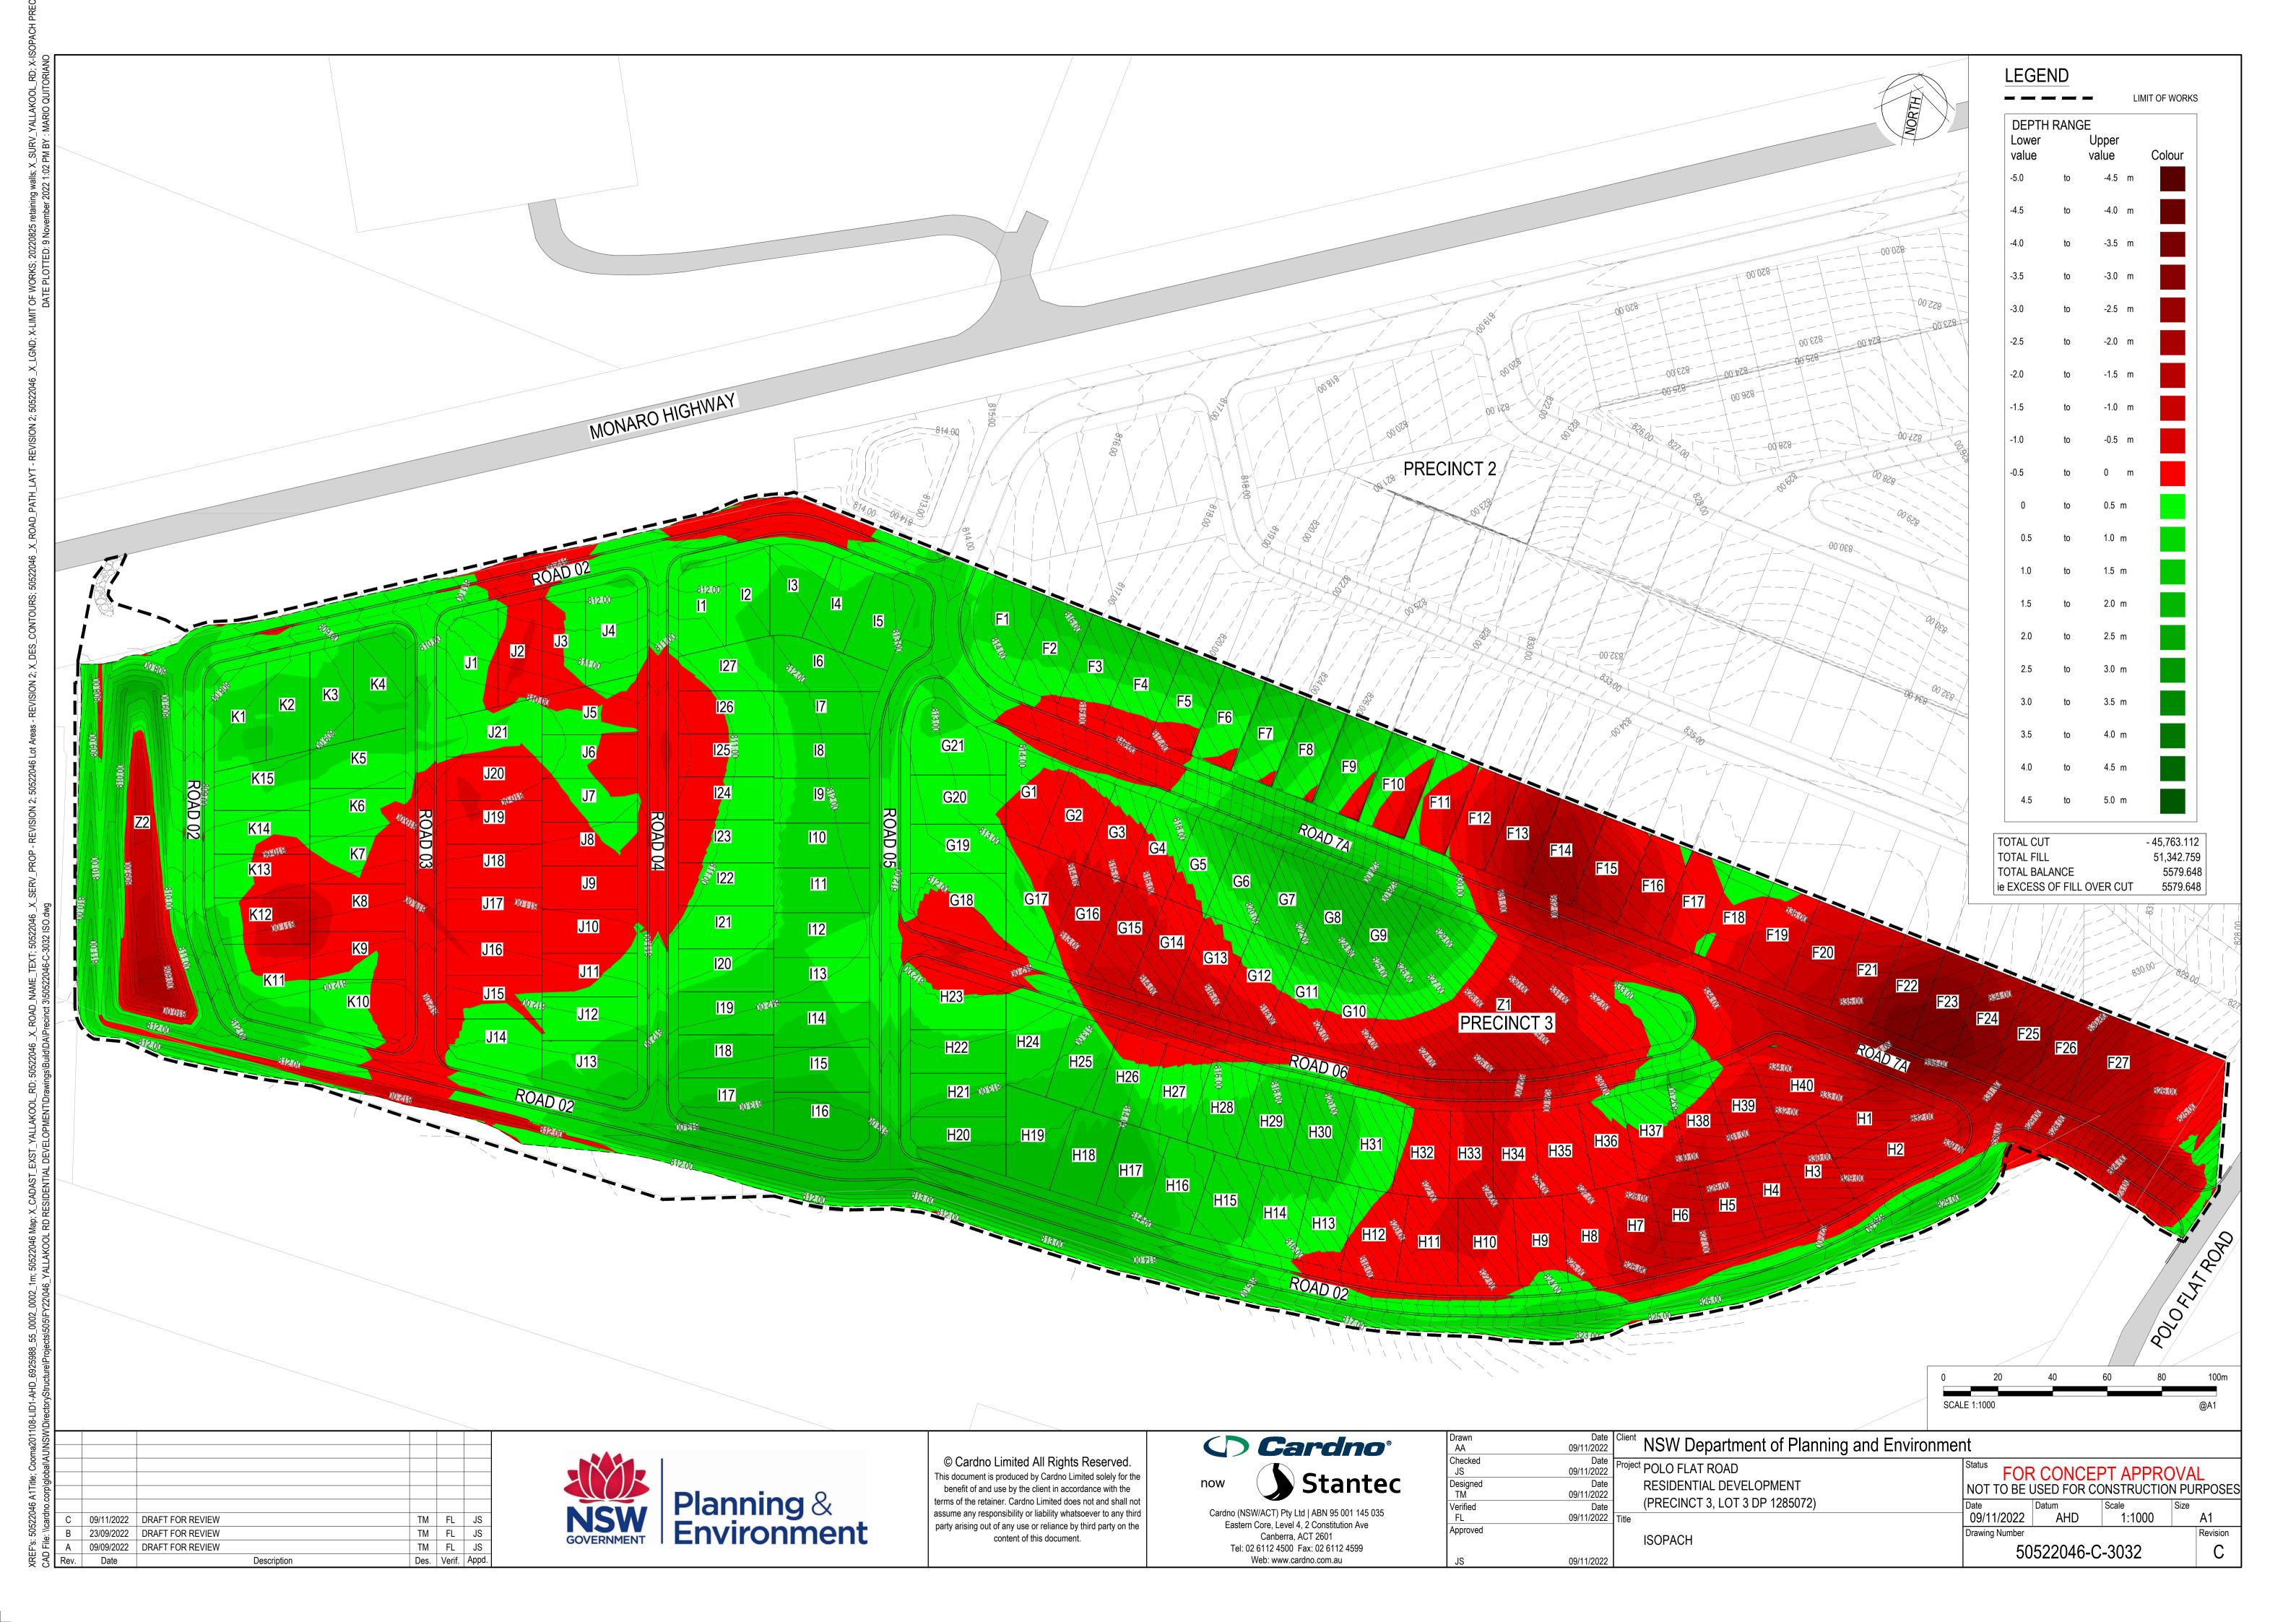
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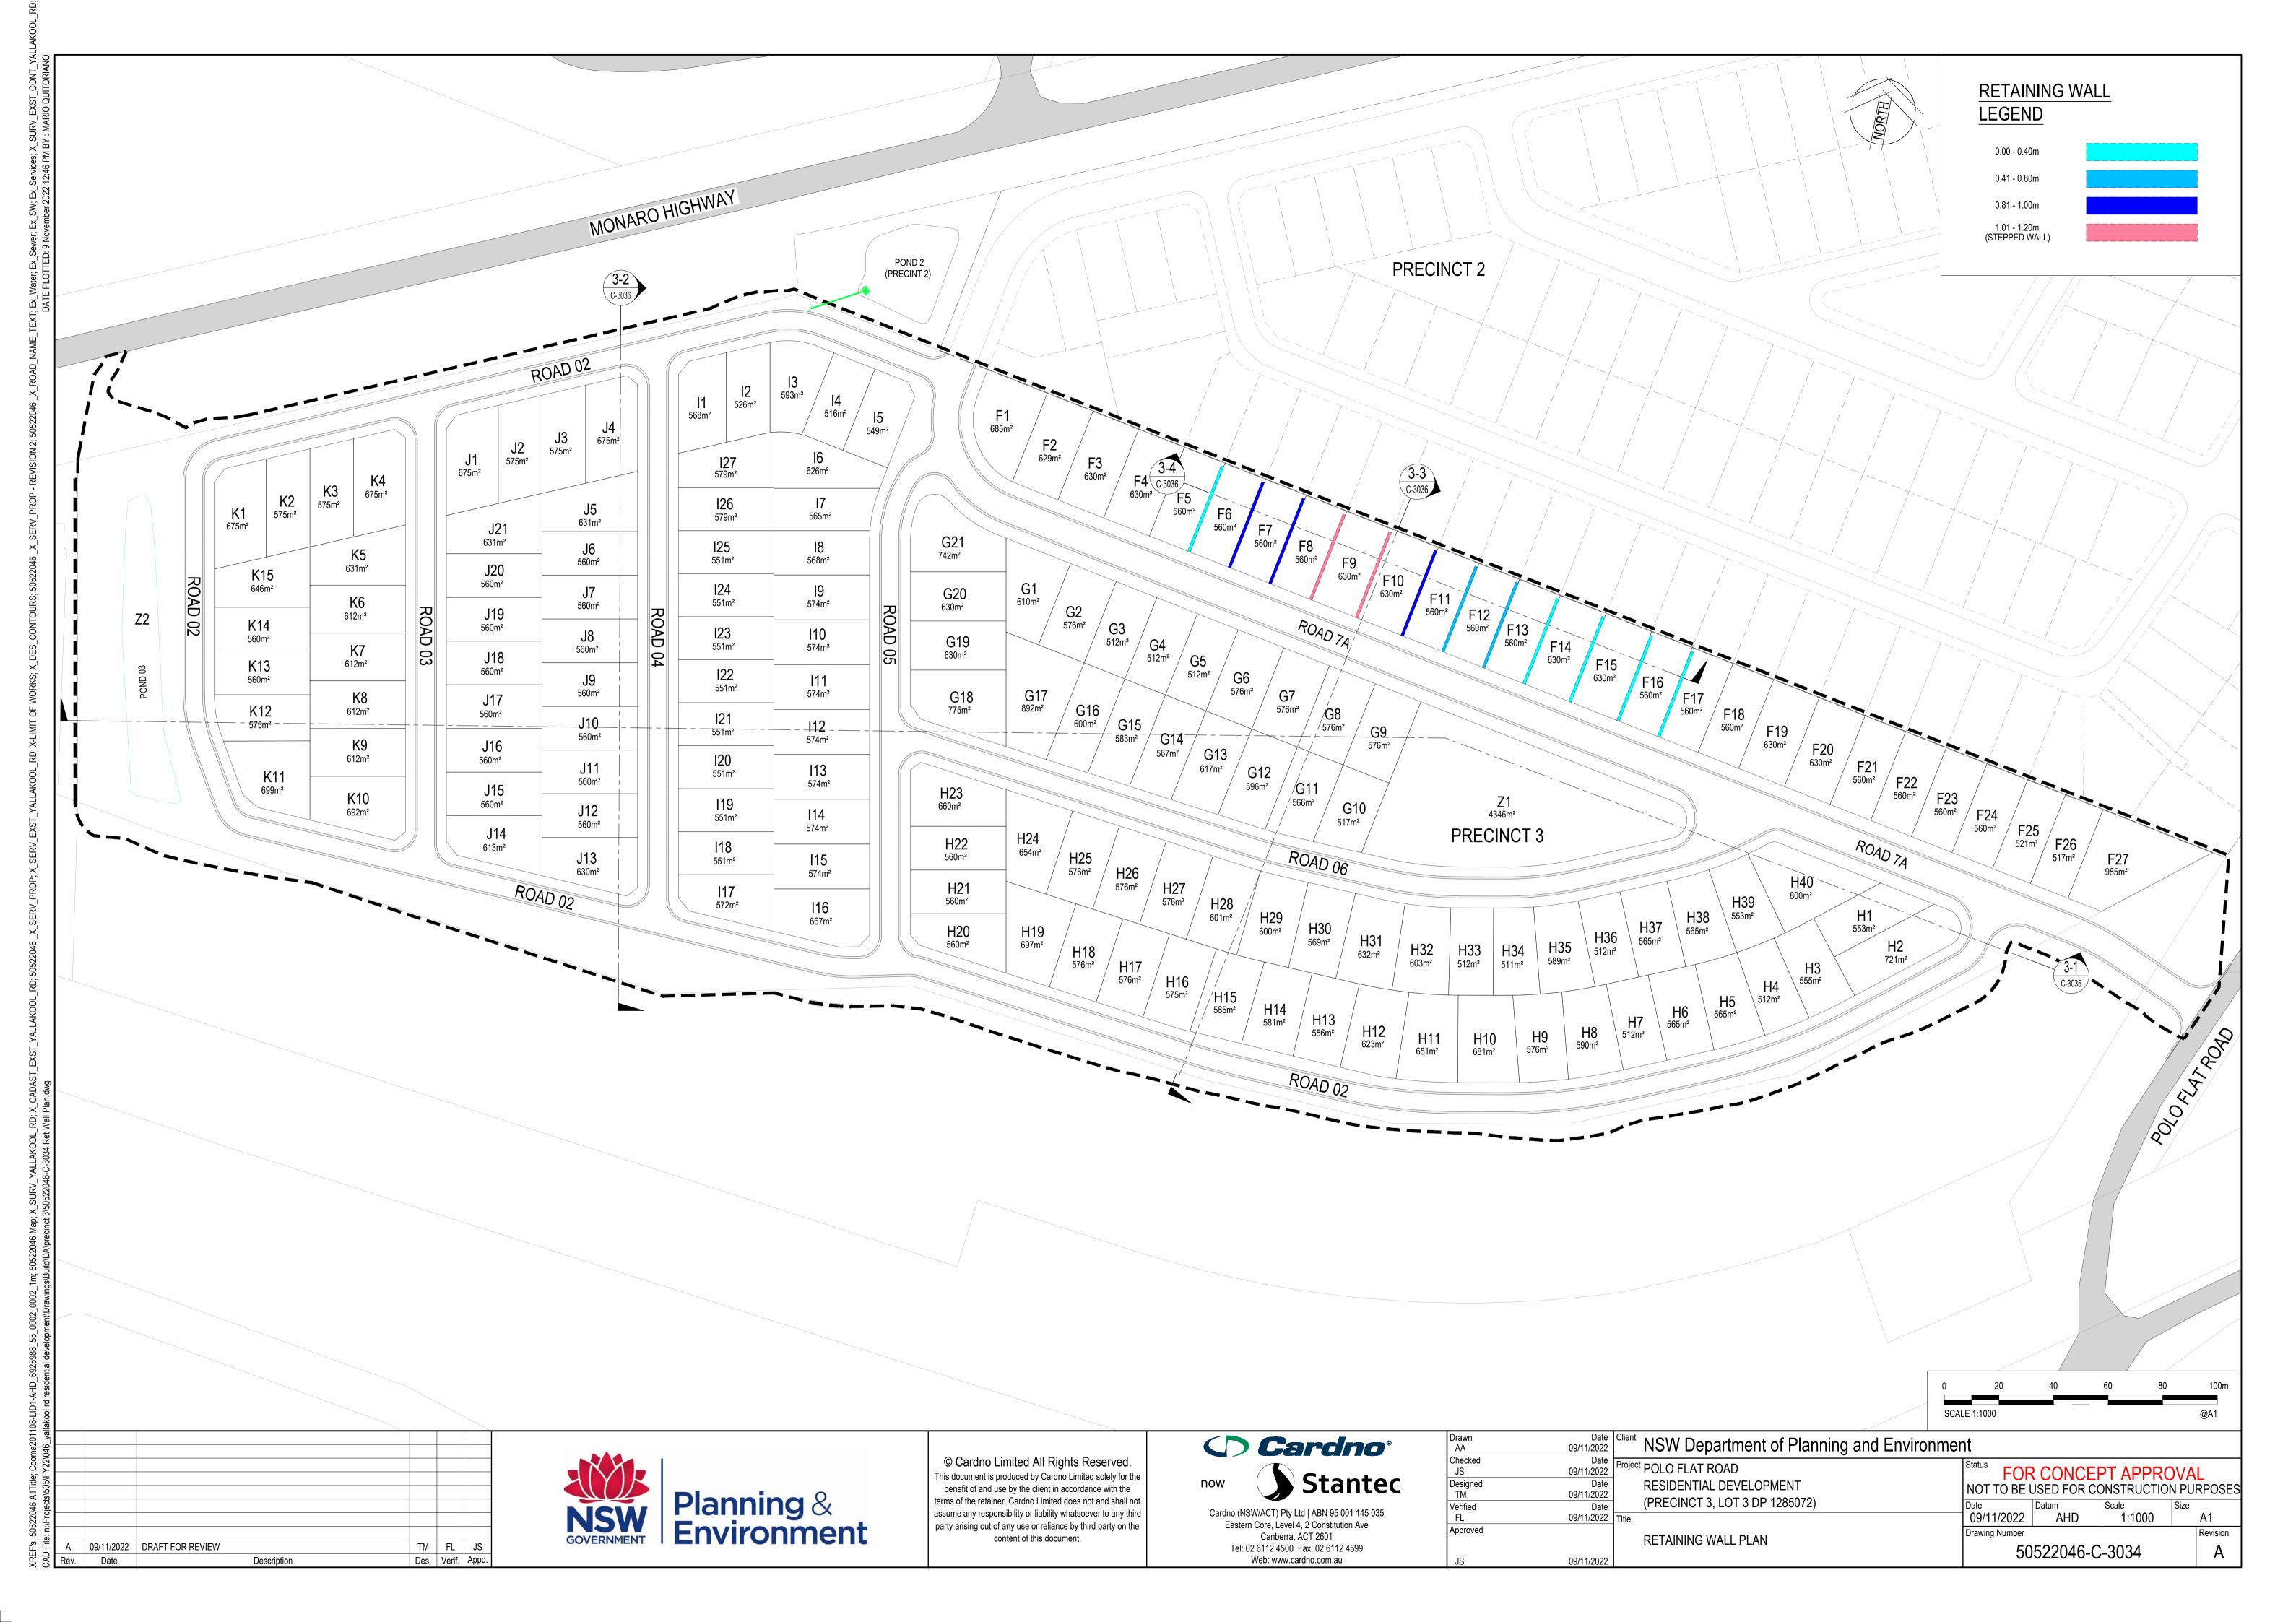
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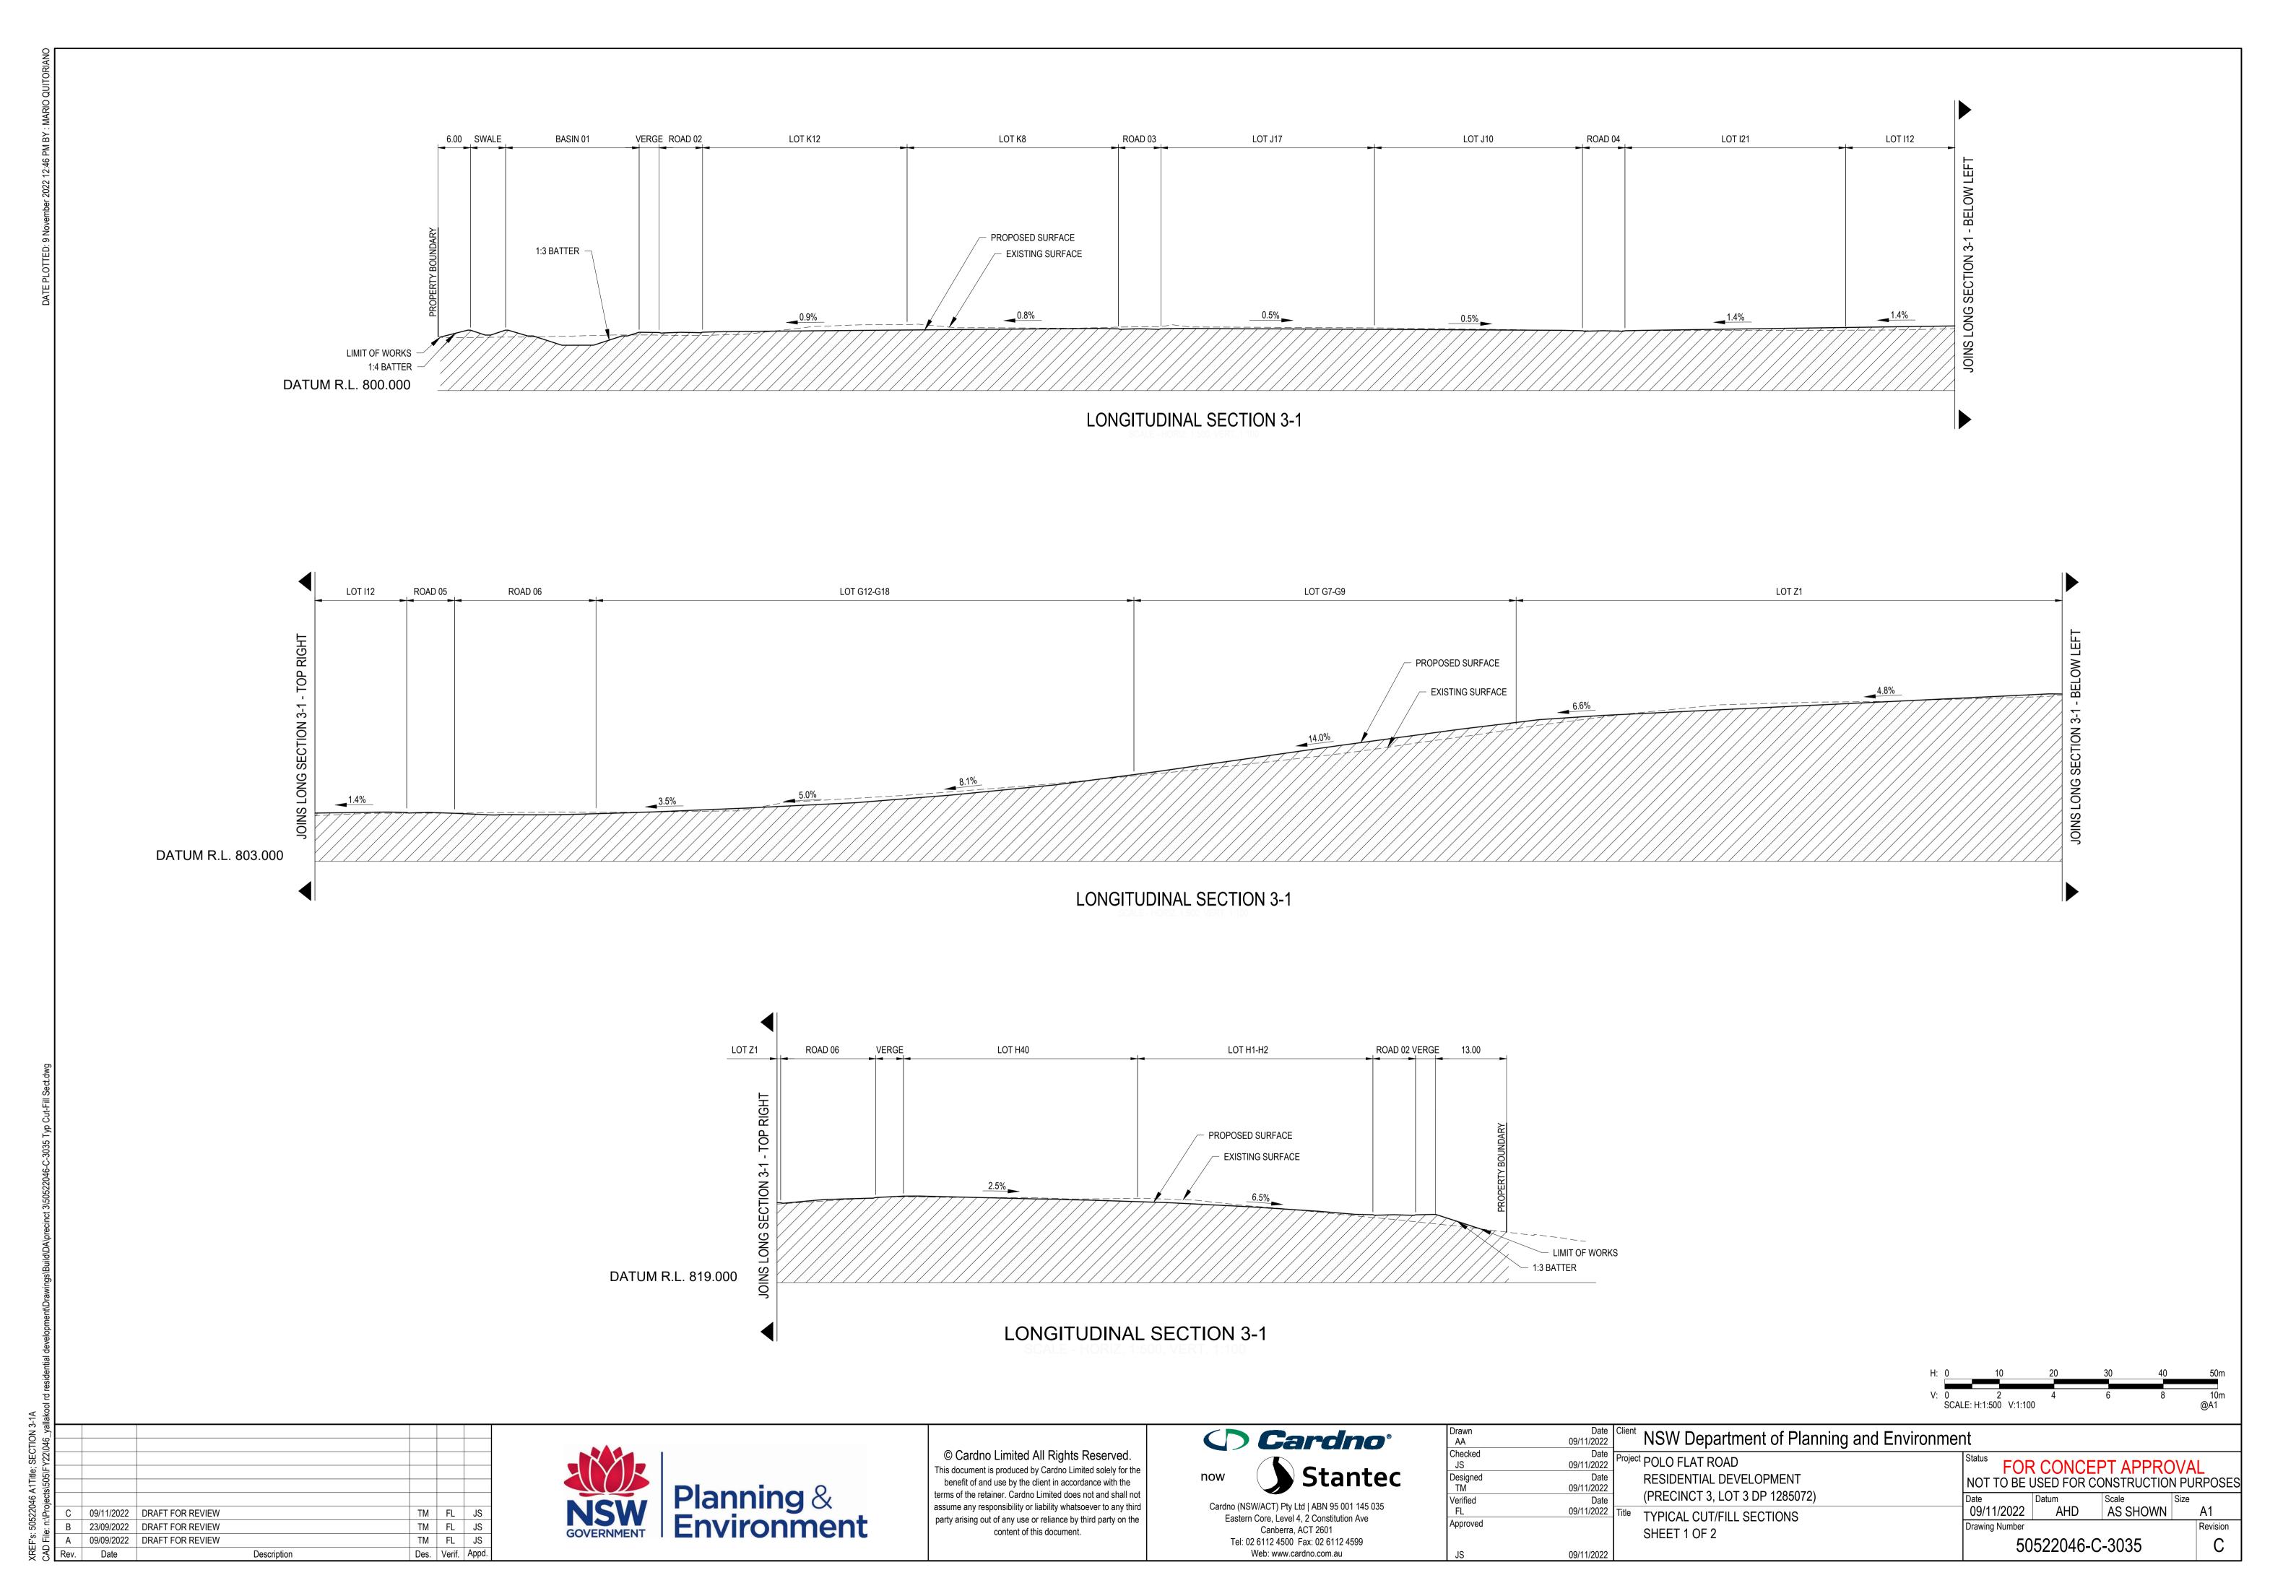
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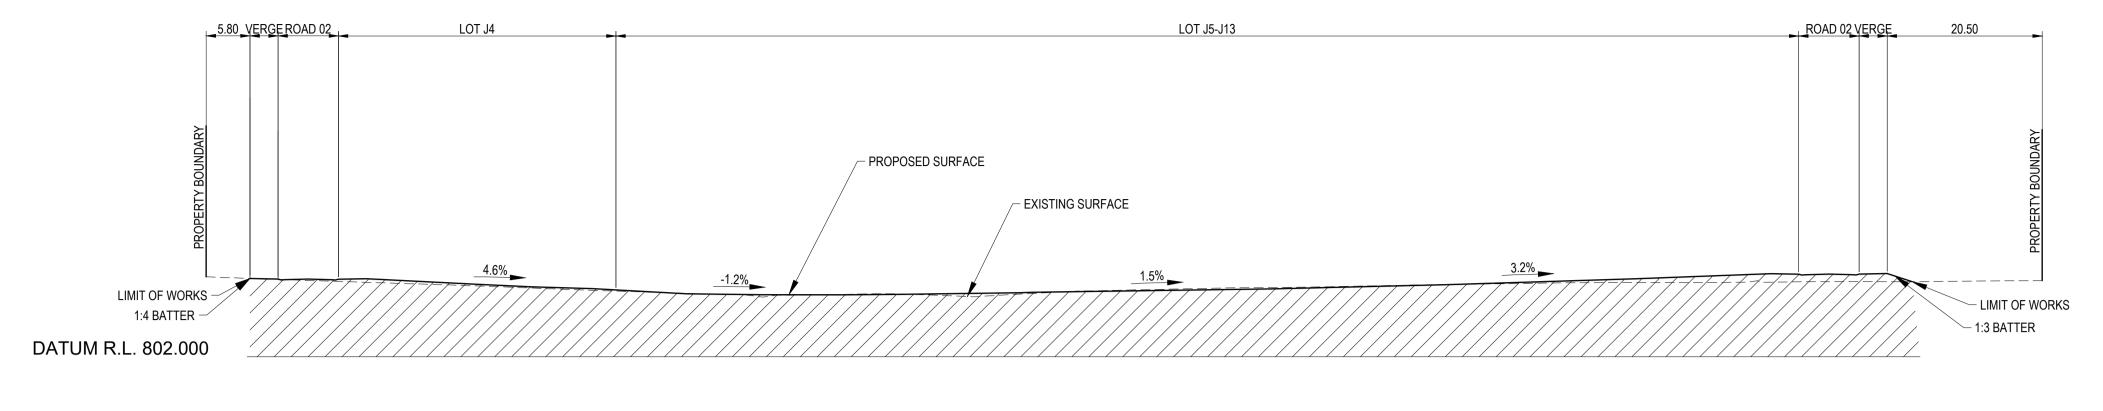
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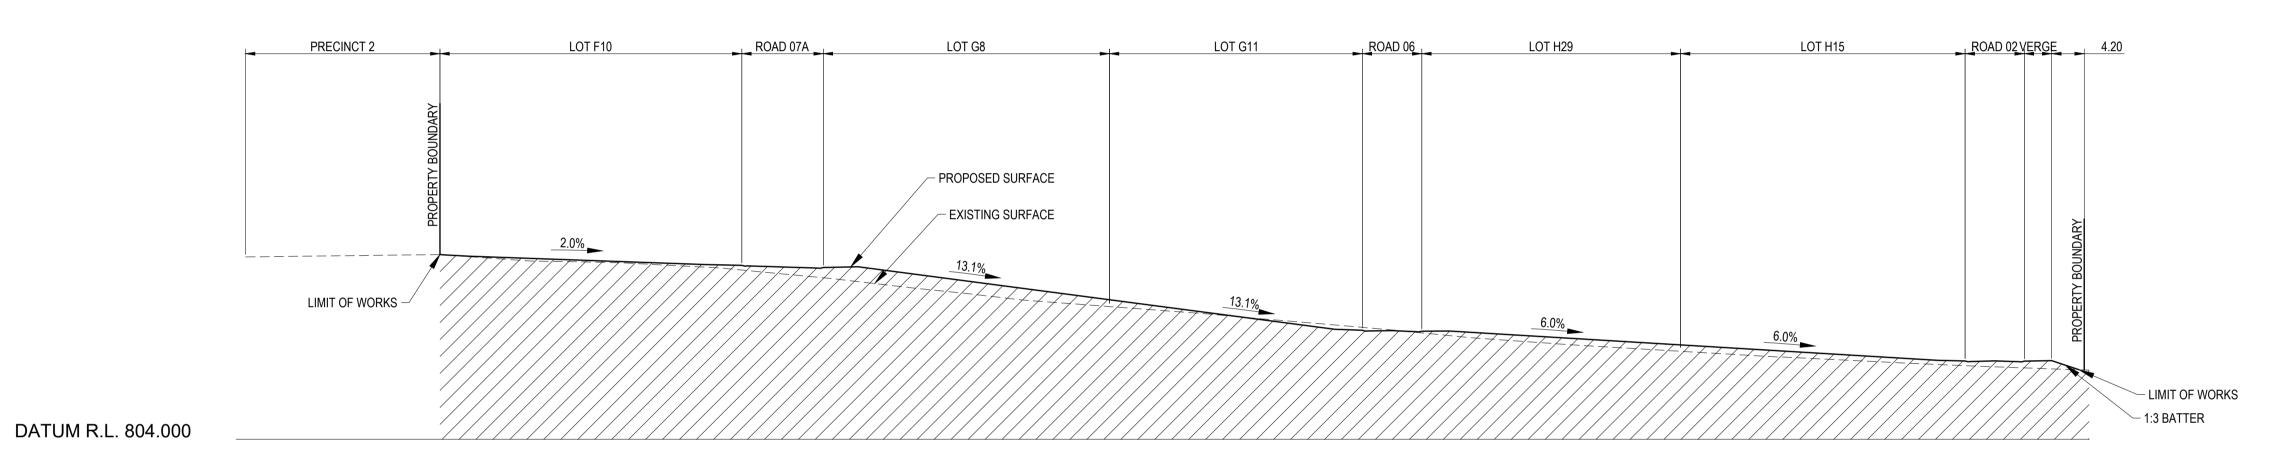










## LONGITUDINAL SECTION 3-2



## LONGITUDINAL SECTION 3-3

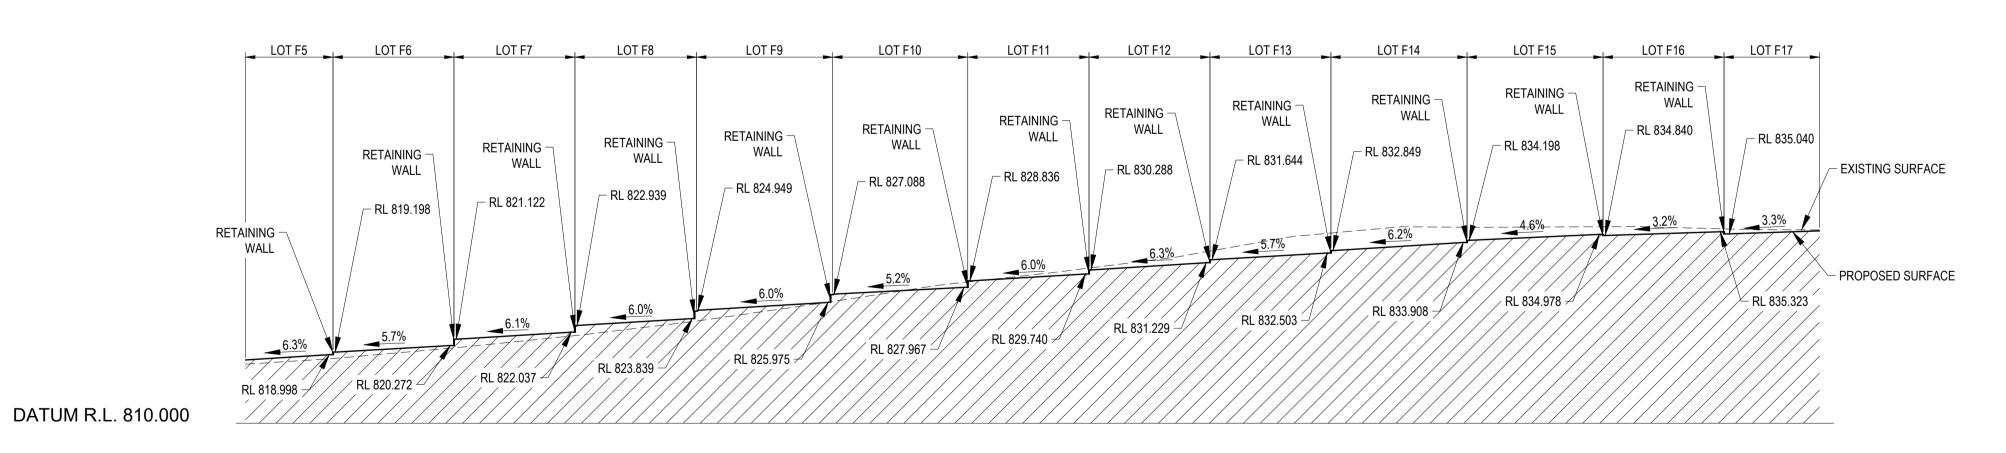

## LONGITUDINAL SECTION 3-4

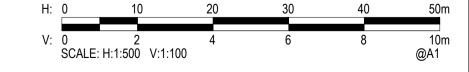


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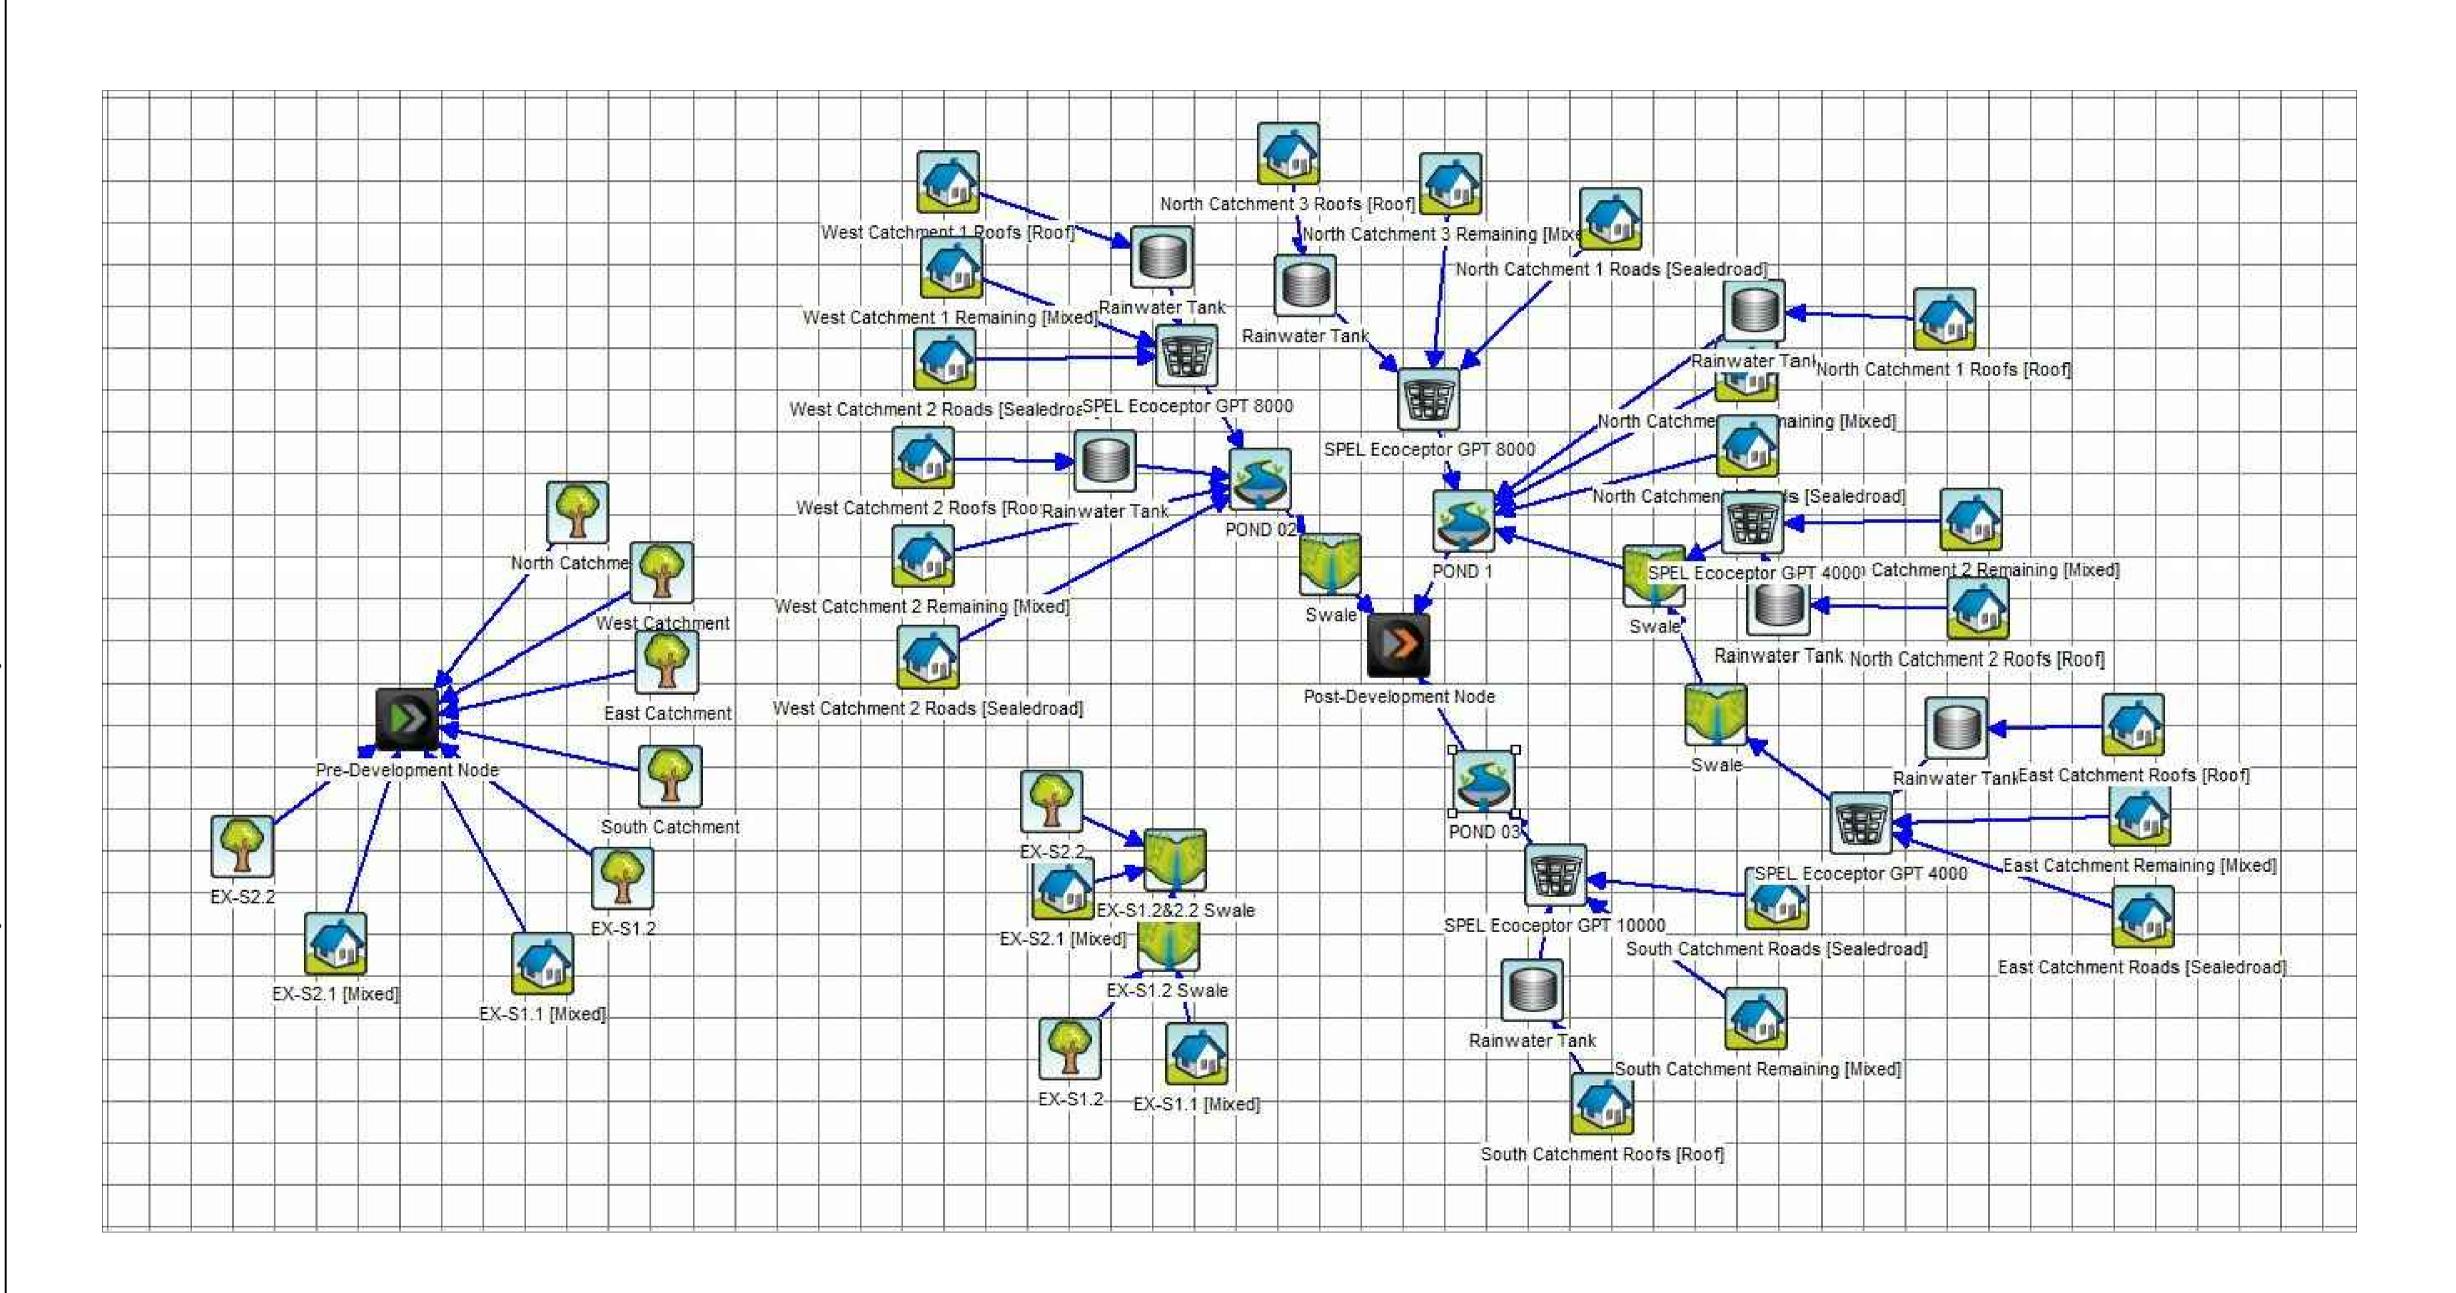




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erified FL	Date 09/11/2022	Title	(PRECINCT 3, LOT 3 DP 1285072)  TYPICAL CUT/FILL SECTIONS	Date 09/11/2022	Datum AHD	Scale AS SHOWN	Size	A1
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Parameters	Sources	Residual Load	% Reduction	% Target	Compliance
Flow (ML/yr)	93.5	77.1	17.6		
Total Suspended Solids (kg/yr)	1.18E+04	1.77E+03	85	80	Υ
Total Phosphorus (kg/yr)	22.6	7.86	65.2	45	Υ
Total Nitrogen (kg/yr)	217	93.8	56.9	45	Υ
Gross Pollutants (kg/yr)	3.30E+03	0	100		

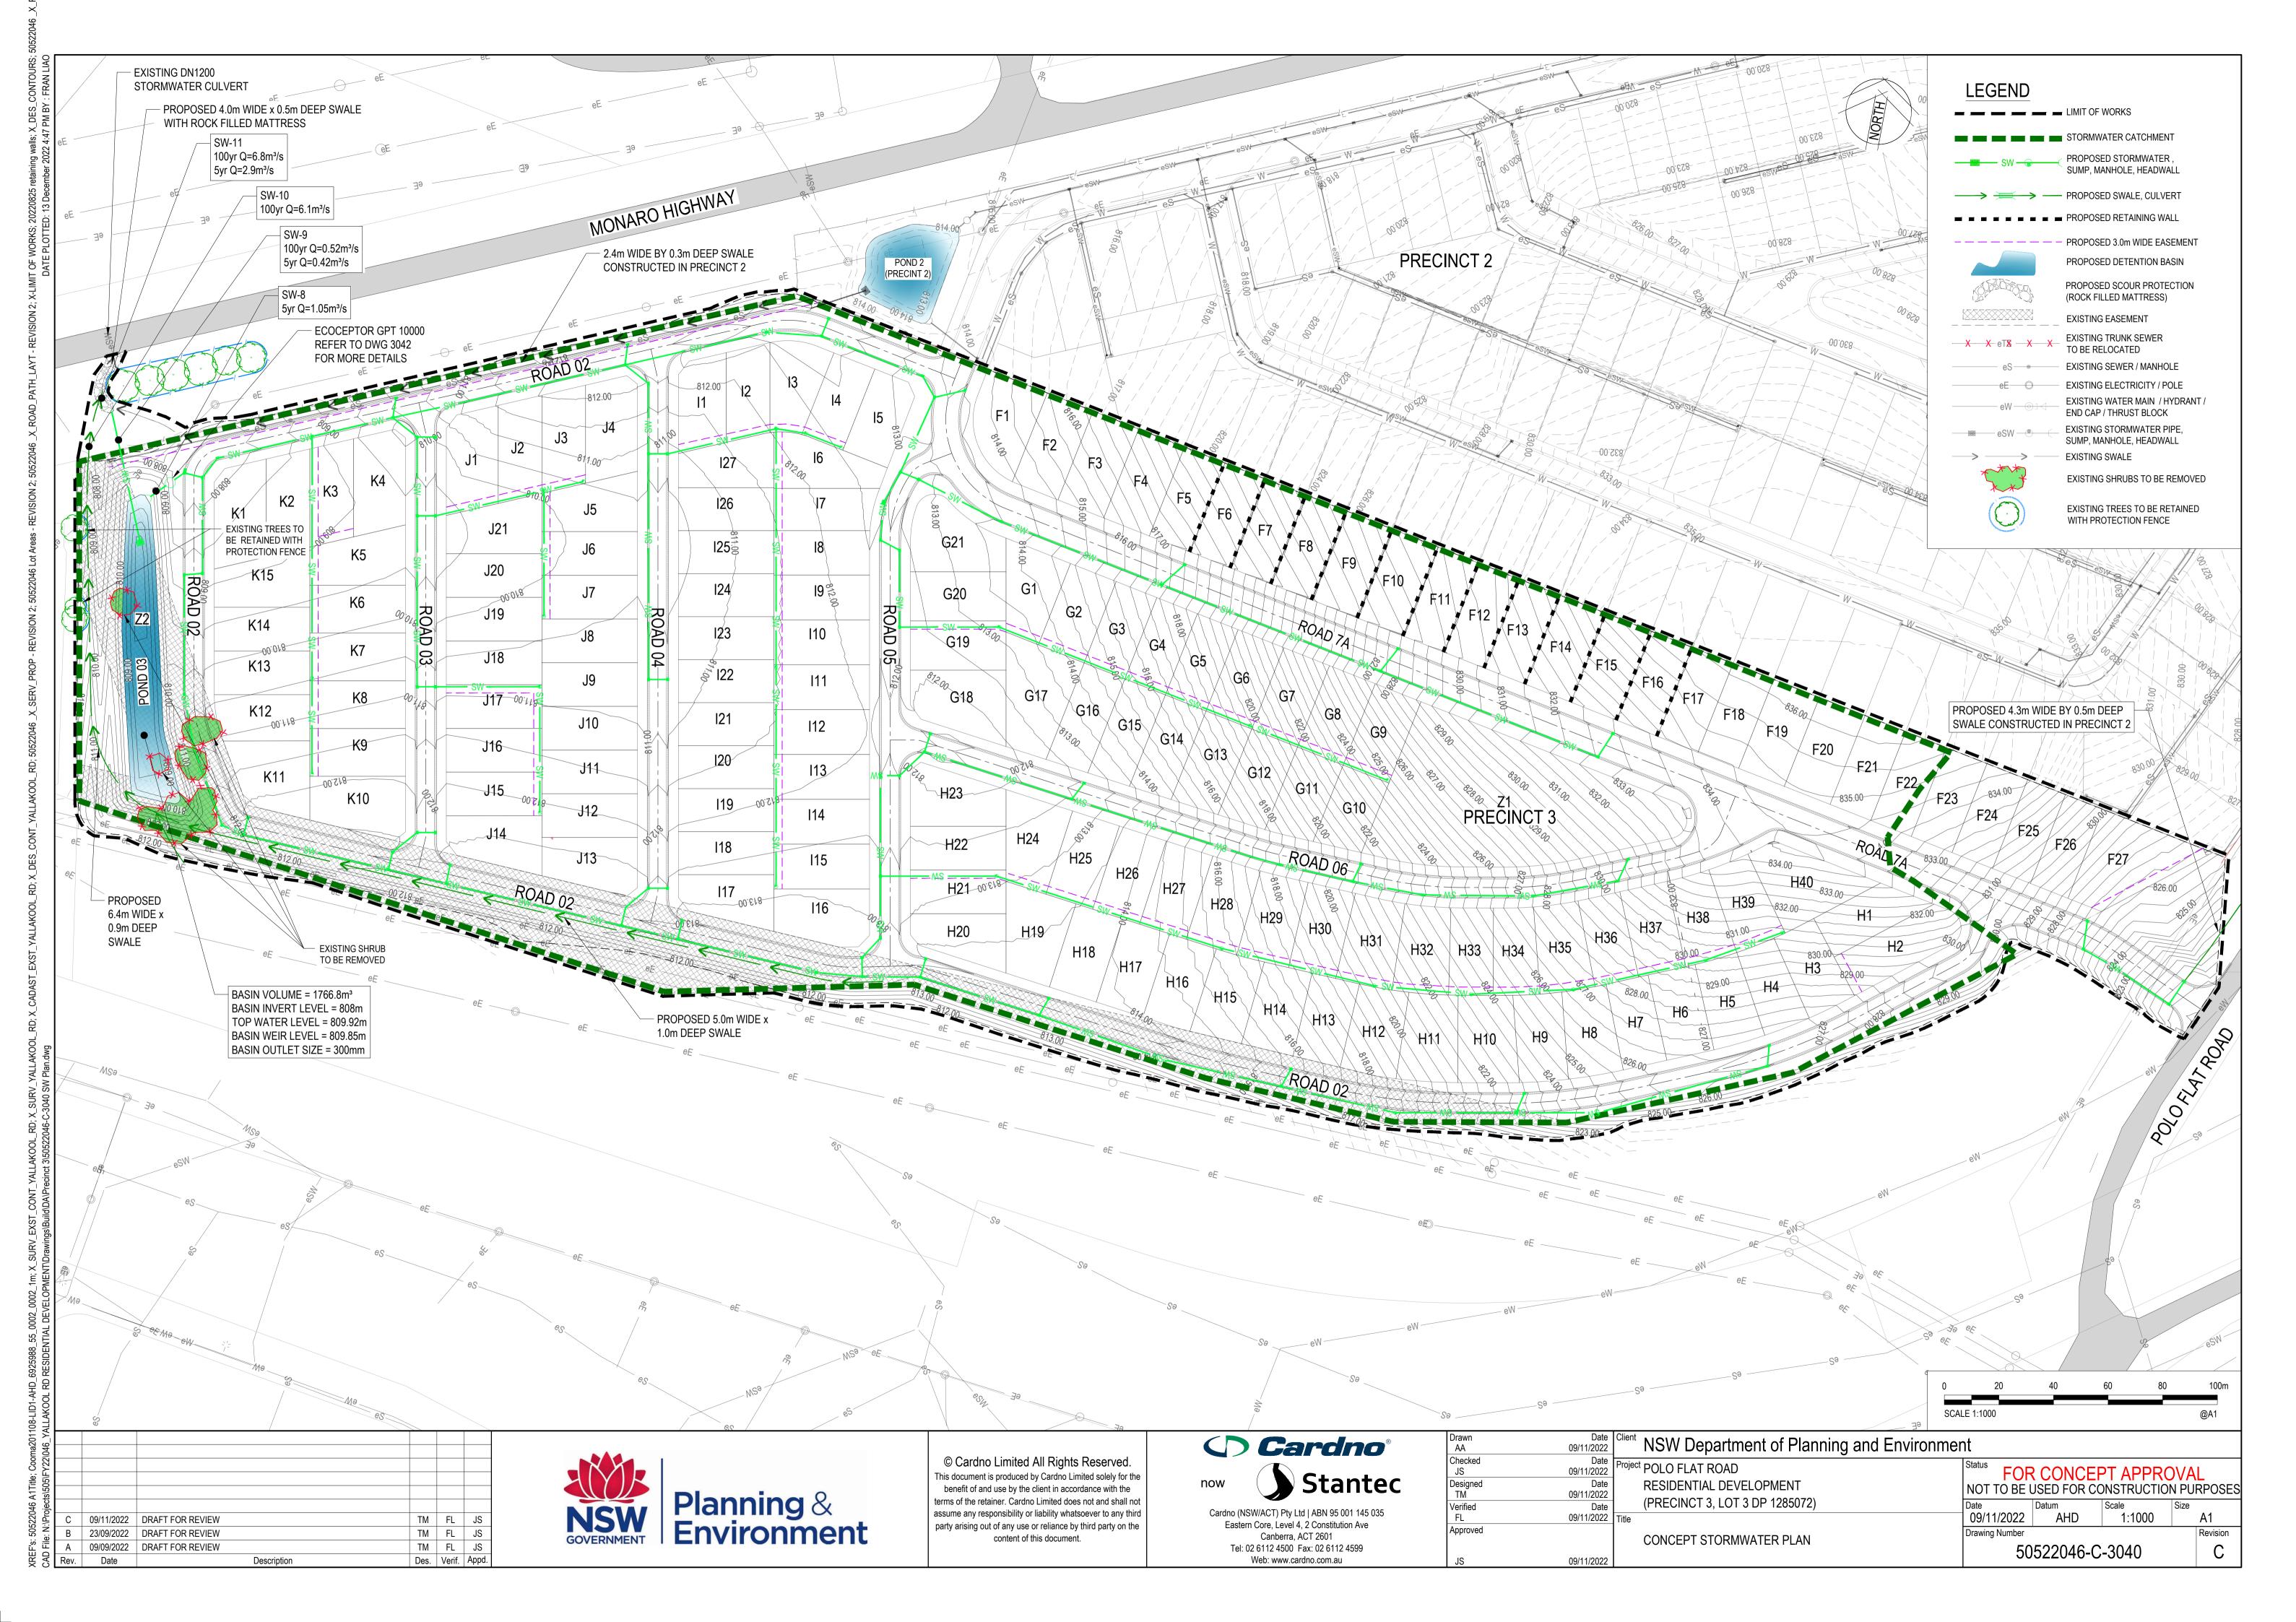

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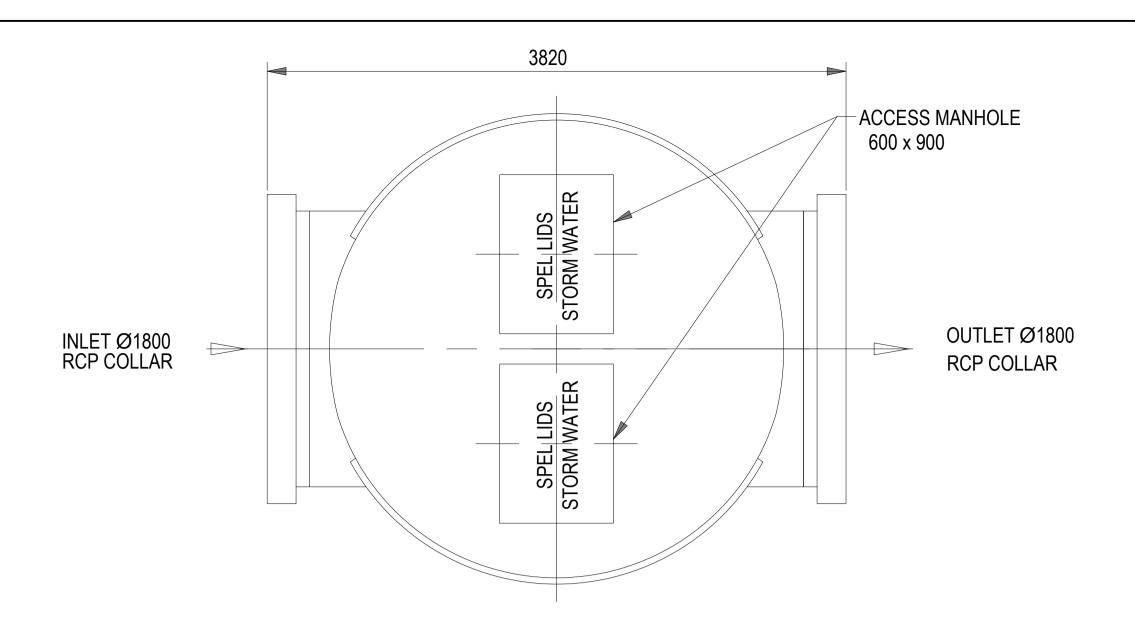
Client NSW Department of Planning and Environment Project POLO FLAT ROAD RESIDENTIAL DEVELOPMENT

(PRECINCT 3, LOT 3 DP 1285072)


Title WATER SENSITIVE URBAN DESIGN OUTCOME PLAN AND QUALITY TABLE


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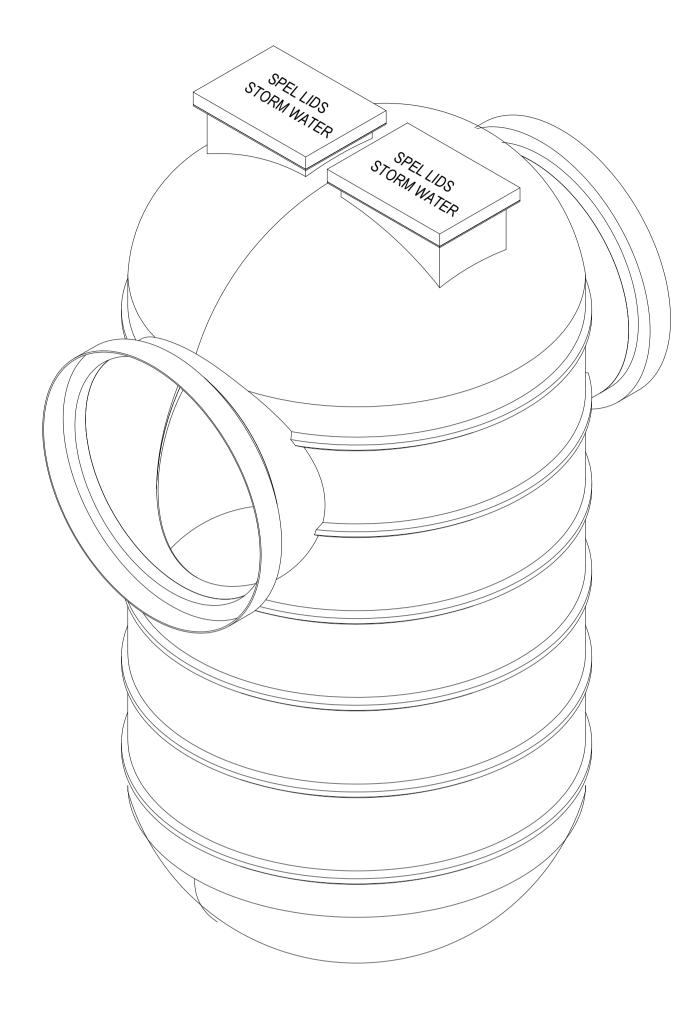
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## **PLAN VIEW**





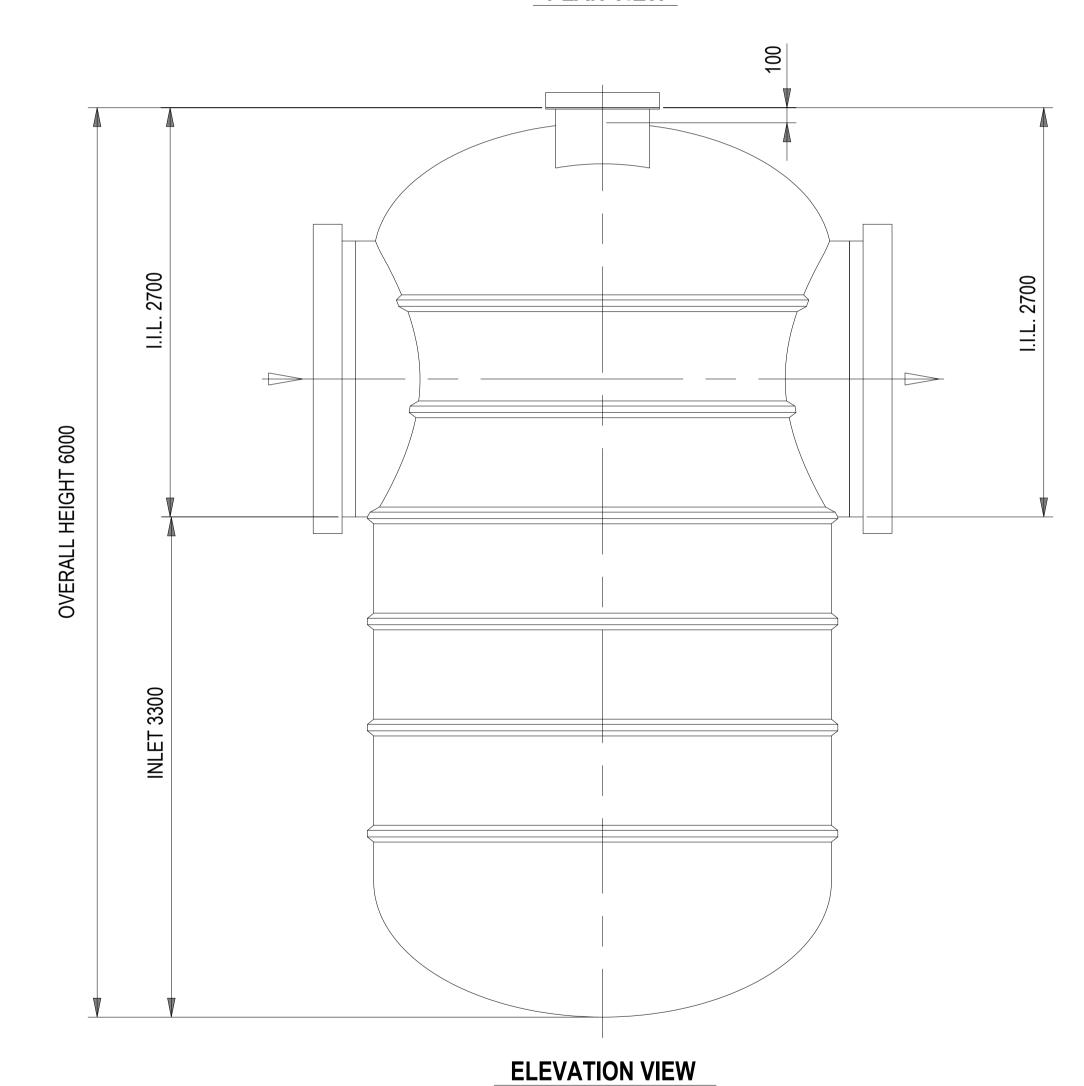

**ISOMETRIC VIEW** 

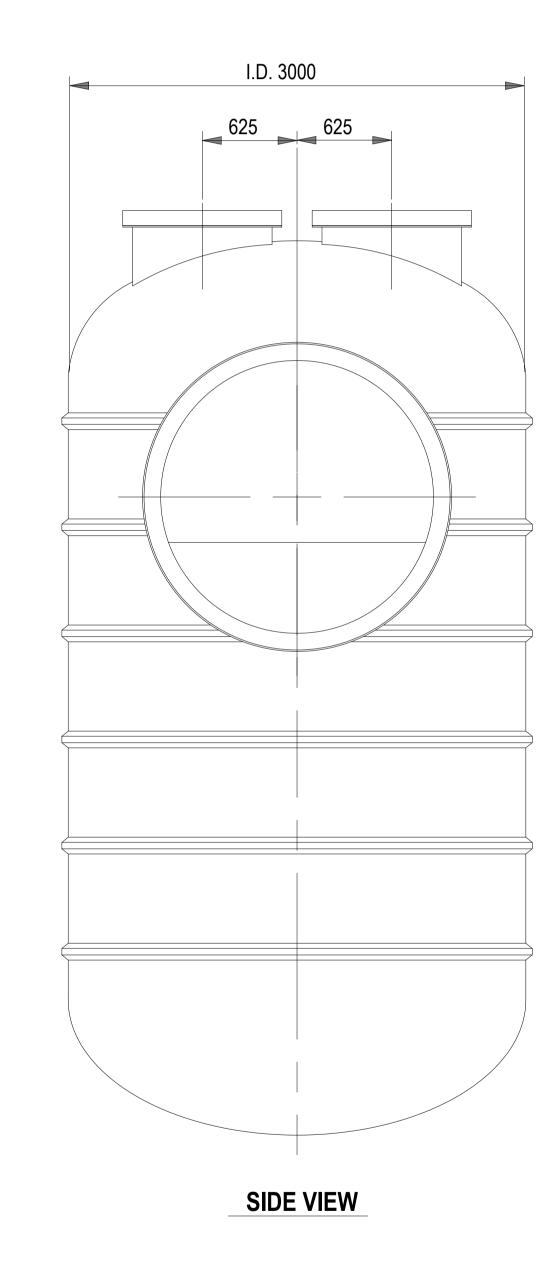TOLERANCE: ALL DIMENSIONS TO CLOSEST 10mm +/- 30mm UNLESS OTHERWISE STATED.

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